




NOTE: ALL IRON PINS SET ARE 5/8" X 30" AND ARE CAPPED BABCOCK, JONES & ASSOC.

NOT TO SCALE

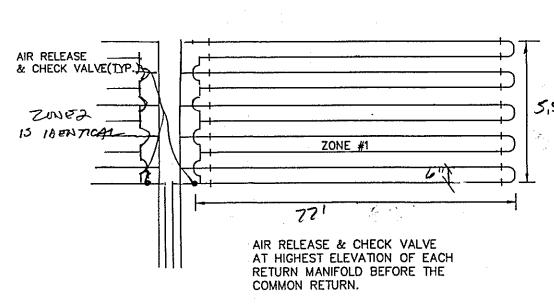

EACH LATERAL WILL FEED FROM THE LOWER RUN IN THE LATERAL AND RETURN FROM THE HIGHER RUN IN THE LATERAL.

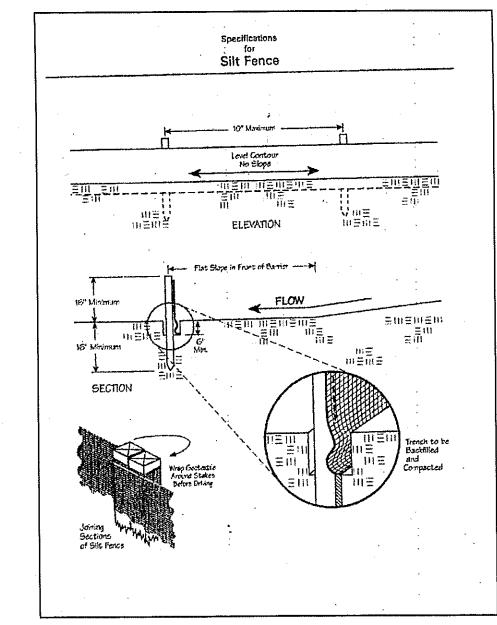

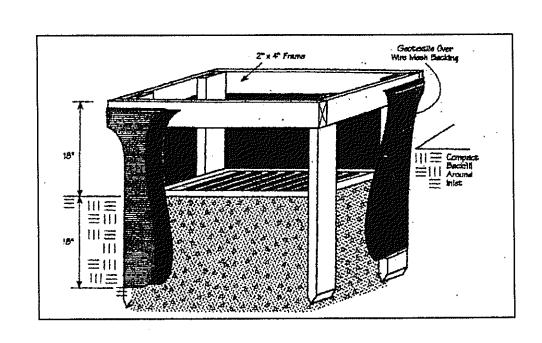


"I CERTIFY THIS SEWAGE SYSTEM DESIGN MEETS THE MINIMUM REQUIREMENTS ESTABLISHED BY THE LCGHD IN THE HSTS GUIDANCE MANUAL, AND THE REQUIREMENTS AND RECOMMENDATIONS OF THE SYSTEM MANUFACTURER."

8A-24B-22

this topography indicated by 6", 1' or 2' contours, and elevations shown hereon represent an actual field survey made by me on the 30" day of 100, 20 05 and that the elevations were taken at appropriate intervals and that as of that date they existed as indicated because

date they existed as indicated hereon."

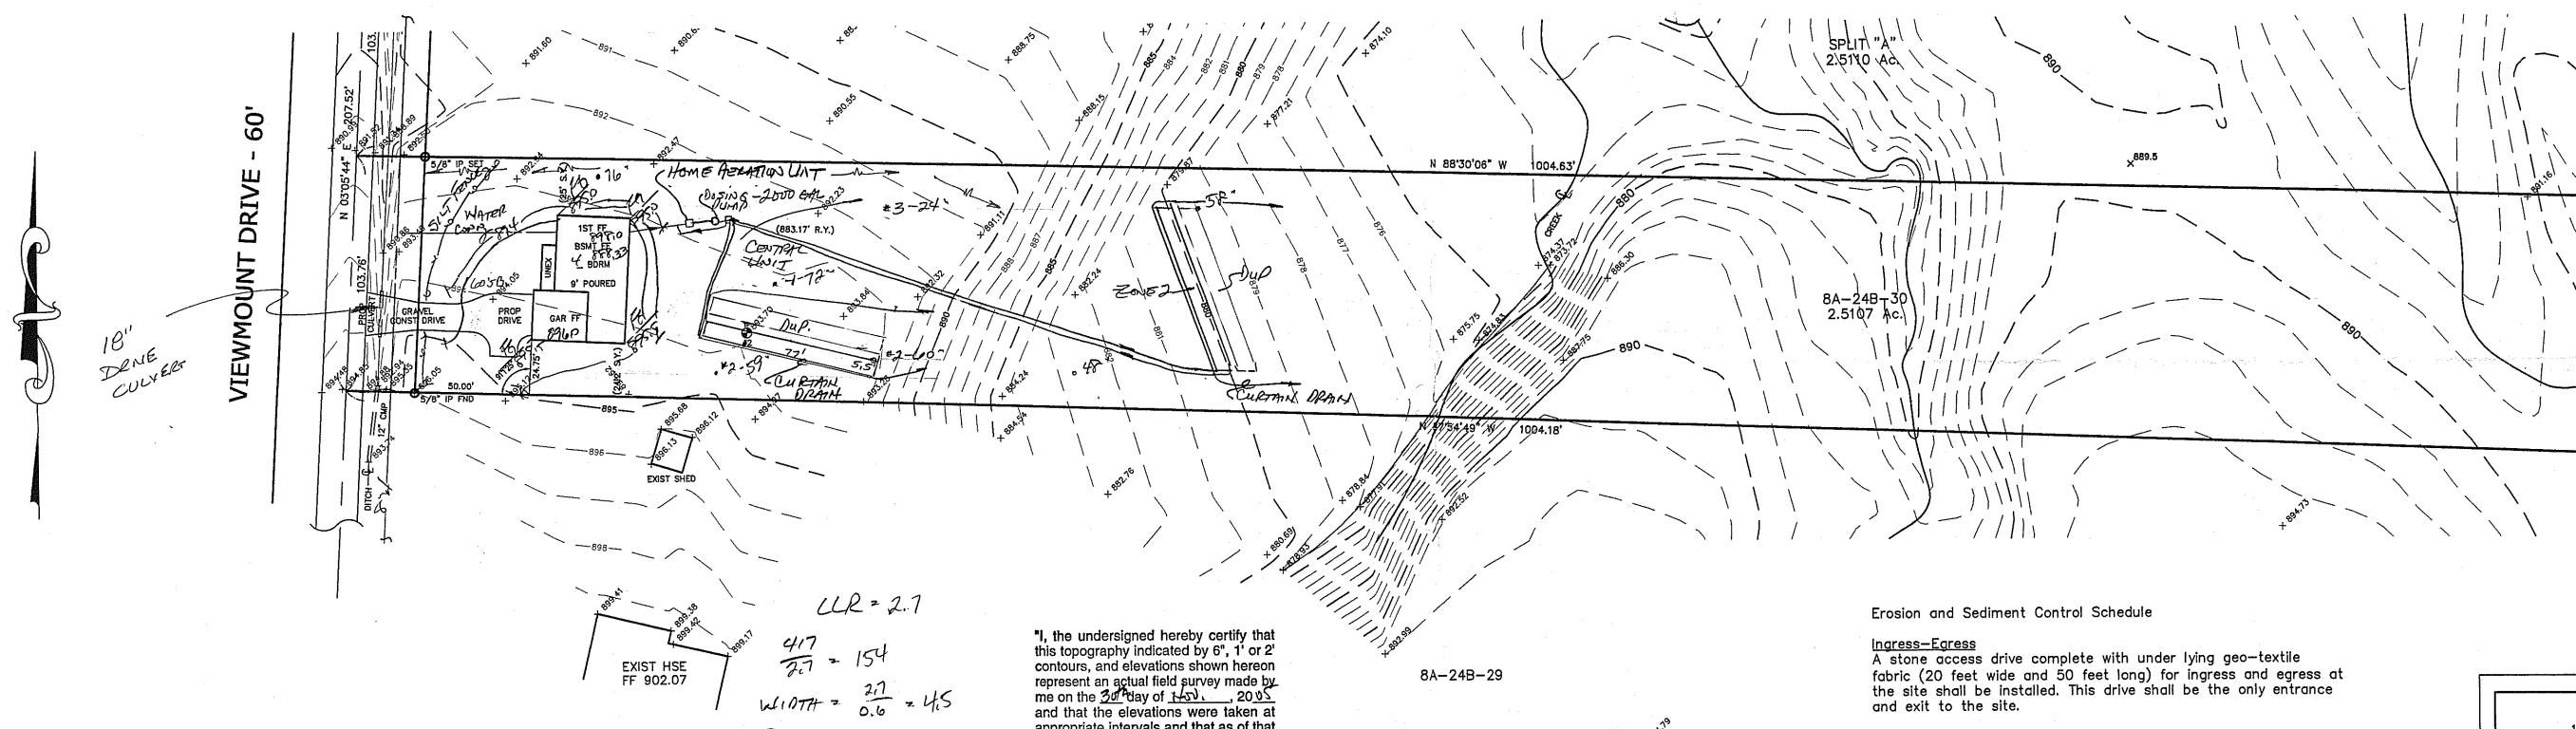

appropriate intervals and that as of that

date they existed as indicated hereon."

drip distribution plan submittal review

(IN FEET)

1 inch = 40 ft.

6 5/8" IP FND

CONCORD TOWNSHIP ZONING OFFICE Zoning Permit # 0206~125億 Date Issued ___ ンパックロン

Subject to Approval By:


Lake Co. Engineer/Storm Water Mgmt.

☐ Lake Co. Utilities Dept.
☐ Lake Co. Soil + Water District

Lake Co. Health District

Lake Co. Building Dept.

Drip distribution area has been field verified and protected with marking tape Plans submitted to LCGHD and meet design criteria (-tydraulic calculations verified and accurate) GRAPHIC SCALE

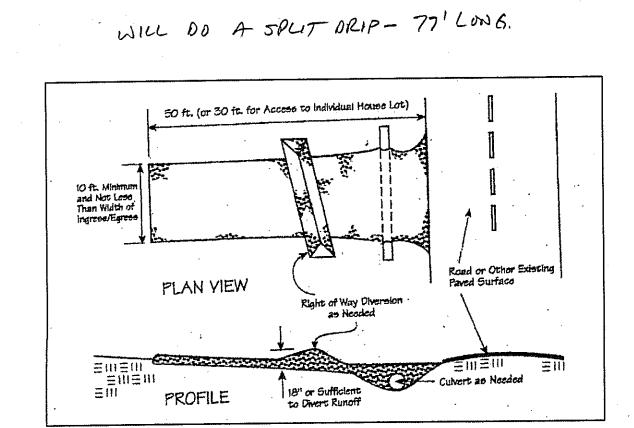

10×154 = 1540 L. TOTAL LIDES

Seeding Dates	Species	Lb./1,000 ft. ²	Per Ac.
March 1 to August 15	Oats Tall Fescue Annual Ryegrass	3 1 1	4 bushel 40 lb. 40 lb.
	Perennial Ryegrass Tall Fescue Annual Ryegrass	1 1 1	40 lb. 40 lb. 40 lb.
August 16 to November 1	Rye Tall Fescue Annual Ryegrass	3 1 1	2 bushel 40 lb. 40 lb.
	Wheat Tall Fescue Annual Ryegrass	3 1 1	2 bushet 40 lb. 40 lb.
	Perennial Ryegrass Tall Fescue Annual Ryegrass	1 1 1	40 lb. 40 lb. 40 lb.

and exit to the site.

Silt Fence
A silt fence shall be installed prior to any earthwork activities at the site in the locations shown on the site plan as well as along the front of any lot that slopes towards the street.


Temporary Seeding
Disturbed areas of the site that are to remain idle for more than twenty-one(21) days shall be properly seeded and straw mulched

within seven(7) days of completion of intitial grading.
Temporary seeding and mulching ao a thirty(30) foot strip of the entire front of the lot shall be maintained on the site once initial grading is complete. Stabilization of critical areas within fifty(50) feet of any stream

or wetland shall be complete within two(2) days of the disturbance if the site is to remain inactive for longer than fourteen(14) days.

Mulching Straw—mulch shall be applied at a rate of 1 bale per every ten (10) feet of curb, at a width of thirty(30) feet to the entire length of the lot. Wood chips may also be used but must be spread at a minimum depth of four inches over the thirty—foot width and must be accompanied by a properly installed silt

Erosion and sediment controls shall be inspected every seven(7) days or within 24 hours of a 0.5" or greater rainfall event. Necessary repairs shall be made at this time.

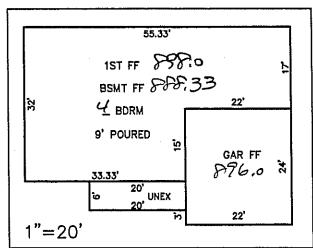

TBM - T.S.F.H. ELEV - 904.44

EXISTING UTILITIES NOTE:
THE SIZE AND LOCATION, BOTH HORIZONTAL AND VERTICAL
OF THE UNDERGROUND UTILITIES SHOWN HEREON, HAVE BEEN
OBTAINED BY A SEARCH OF AVAILABLE RECORDS.
VERIFICATION BY FIELD OBSERVATION HAS BEEN CONDUCTED
WHERE PRACTICAL, HOWEVER, BABCOCK, JONES AND ASSOCIATES
INC. DOES NOT GUARANTEE THE COMPLETENESS NOR ACCURACY
THEREOF.



REV NO.	DESCRIPTION	DATE	BY	CHK,D
1	MOVED HOUSE TO 50' SETBACK	12/8/05	B.P.	H.J.
				+

JONIES AND ASSOCIATES INC

JONES AND ASSOCIATES, INC	DR
GINEERS - SURVEYORS - LAND PLANNERS	AP
PAINESVILLE OHIO 44077	CR

DATE	12/2/05	
Design by	H.J.	
DRAWN BY	B.P.	
APPROVED BY	H.J.	
ADDIV OUIEE		

SITE PLAN FOR

CONCORD TOWNSHIP

TOM LONCAR VIEWMOUNT DRIVE (P.P.# 8A-24B-₩) STATE OF OHIO LAKE COUNTY

1"=40' 05-224-73