

COURT

601

EXISTING UTILITIES NOTE:
THE SIZE AND LOCATION, BOTH HORIZONTAL AND VERTICAL
OF THE UNDERGROUND UTILITIES SHOWN HEREON, HAVE BEEN
OBTAINED BY A SEARCH OF AVAILABLE RECORDS.
VERIFICATION BY FIELD OBSERVATION HAS BEEN CONDUCTED
WHERE PRACTICAL, HOWEVER, BABCOCK, JONES AND ASSOCIATES
INC. DOES NOT GUARANTEE THE COMPLETENESS NOR ACCURACY
THEREOF.

CURVE TABLE

CURVE LENGTH RADIUS TANGENT CHORD BEARING DELTA

C1 79.54 60.00 46.84 73.84 S69'00'17"E 75'57'08"

"AS BUILT" CERTIFICATION
I, HEREBY CERTIFY THAT THE CIRCLED GRADES ARE EXISTING
FINISH GRADES CHECKED IN THE FIELD ON _______, 20______,
AND ARE CORRECT TO THE BEST OF MY KNOWLEDGE AND BELIEF.

7

T H B

SCALE 1"=20' PHONE NO.

DATE 12/30/04 DRAWING NO.

APP'D H.J. 03-007-47

PLAN PREPARED BY:
BABCOCK · JONES & ASSOCIATES, INC.

TBM - 5/8" IP FND ELEV - 1009.90

Scormwater Manageme: Approved as shown and/c JAMES R. GILLS, P.I County Drainage Engli By (2.5) Date

MOUNTAINSIDE FARMS II
SUBDIVISION 48-35 NAME
VOL-PG.DAISY HILL
STREET

END END

5/8" IP FND ELEV. 1009.90

LOCATIONS AS SHOWN OF ADJACENT LAKE COUNTY HEALTH DEPARTMENT

DESIGN CERTIFICATION
THIS PLAT WAS PREPARED BY ME, AND IS CORRECT
TO THE BEST OF MY KNOWLEDGE AND BELIEF.

TO THE BEST OF MY KNOWLEDGE AND BELIEF.

CHECK LIST

WATER WAIN SIZE, LOCATION SAN. SEWER SIZE & GR. LOC.
SAN. MH. CAST. ELEV. INV. ELEV.
SIGNAL STORM MH. CAST. ELEV. INV. ELEV.
SIGNAM MH. CAST ELEV. INV. ELEV.
SIGNAM MH. CAST ELEV. INV. ELEV.
SIGNAM MH. CAST ELEV. INV. ELEV.
STORM MH. CAST ELEV.
ST

ing geo—textile ngress and egress at e the only entrance


to any earthwork activities on the site plan as well as pes towards the street.

e to remain idle for more than eded and straw mulched of intitial grading, o a thirty(30) foot strip of maintained on the site once

ation of critical areas within fifty(50) feet of any stresind shall be complete within two(2) days of the ince if the site is to remain inactive for longer than (14) days.

-mulch shall be applied at a rate of 1 bale per every ten eet of curb, at a width of thirty(30) feet to the entire of the lot. Wood chips may also be used but must be I at a minimum depth of four inches over the thirty—foot and must be accompanied by a properly installed silt

:ted every seven(7) rainfall event.

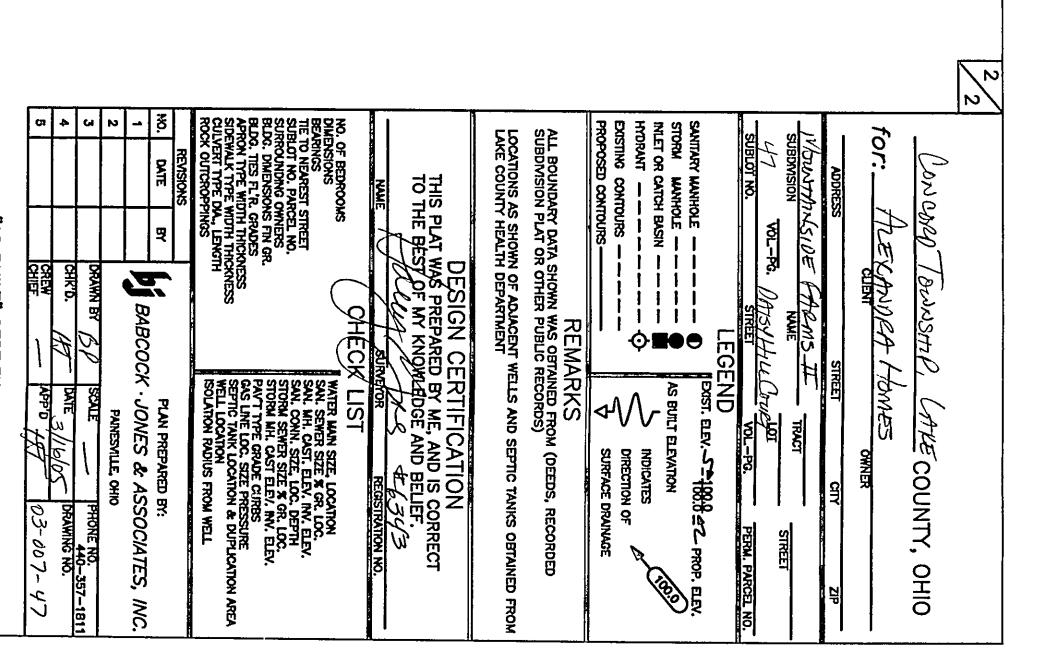

ned hereby certify that indicated by 6", 1', or 2' levations shown hereon that field survey made by day of 12004 evations were taken at rvals and that as of that