Species	Lb./1,000 ft. ²	Per Ac.	
Oats Tall Fescue Annual Ryegrass	Tall Fescue		
Perennial Ryegrass Tall Fescue Annual Ryegrass	1 1 1	40 lb. 40 lb. 40 lb.	
Rye Tall Fescue Annual Ryegrass	3 1 1	2 bushel 40 lb. 40 lb.	
Wheat Tall Fescue Annual Ryegrass	3 1 1	2 bushet 40 lb. 40 lb.	
Perennial Ryegrass Tall Fescue Annual Ryegrass	1 1 1	40 lb. 40 lb. 40 lb.	
	Oats Tall Fescue Annual Ryegrass Perennial Ryegrass Tall Fescue Annual Ryegrass Rye Tull Fescue Annual Ryegrass Wheat Tall Fescue Annual Ryegrass Perennial Ryegrass Tall Fescue	Oats 3 Tall Fescue 1 Annual Ryegrass 1 Perennial Ryegrass 1 Tall Fescue 1 Annual Ryegrass 1 Rye 3 Tull Fescue 1 Annual Ryegrass 1 Wheat 3 Tall Fescue 1 Annual Ryegrass 1 Perennial Ryegrass 1 Tall Fescue 1 Tall Fescue 1 Tall Fescue 1	

Erosion and Sediment Control Schedule

A stone access drive complete with under lying geo—textile fabric (20 feet wide and 50 feet long) for ingress and egress at the site shall be installed. This drive shall be the only entrance and exit to the site.

Silt Fence
A silt fence shall be installed prior to any earthwork activities at the site in the locations shown on the site plan as well as along the front of any lot that slopes towards the street.


Disturbed areas of the site that are to remain idle for more than thirty(30) days shall be properly seeded and straw mulched within seven(7) days of completion of intitial grading. Temporary seeding and mulching ao a thirty(30) foot strip of the entire front of the lot shall be maintained on the site once initial grading is complete.

Stabilization of critical areas within fifty(50) feet of any stream or wetland shall be complete within two(2) days of the disturbance if the site is to remain inactive for longer than fourteen(14) days.

Mulching
Straw—mulch shall be applied at a rate of 1 bale per every ten (10) feet of curb, at a width of thirty(30) feet to the entire length of the lot. Wood chips may also be used but must be spread at a minimum depth of four inches over the thirty-foot width and must be accompanied by a properly installed silt


<u>Maintenance</u>


Erosion and sediment controls shall be inspected every seven(7) days or within 24 hours of a 0.5" or greater rainfall event. Necessary repairs shall be made at this time.

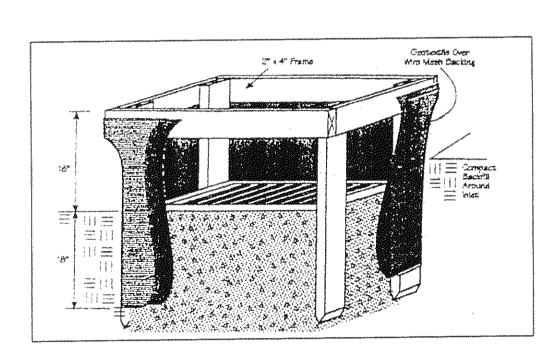


CONCORD TOWNSHIP ZONING OFFICE Zoning Permit # 0405 - 12109
Date Issued 4/13/05 Subject to Approval By: Lake Co. Engineer/Storm Water Mgmt. Lake Co. Utilities Dept. Lake Co. Soil + Water District Lake Co. Health District

Lake Co. Building Dept.

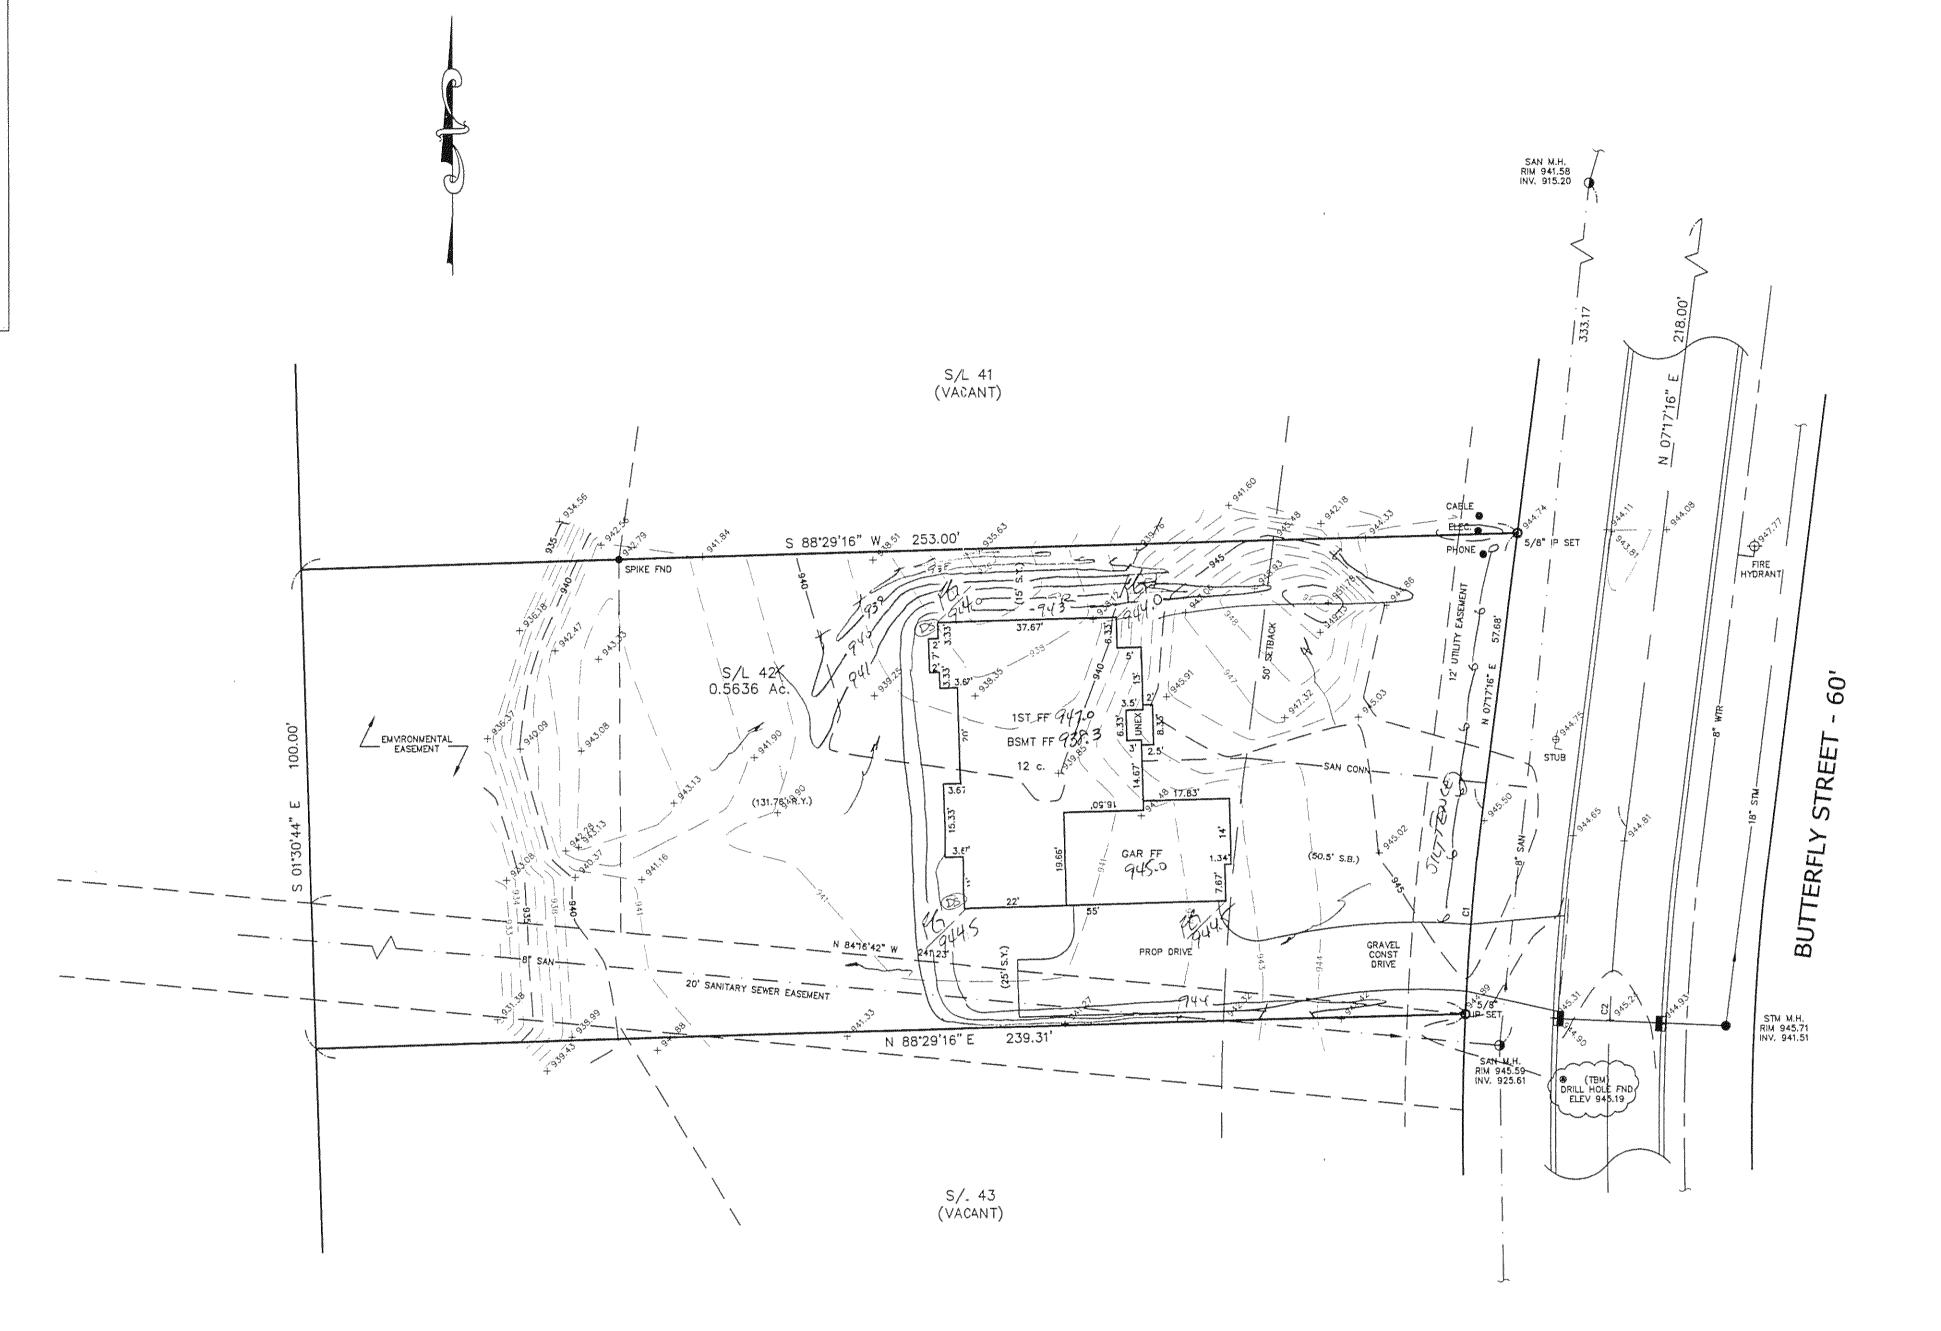

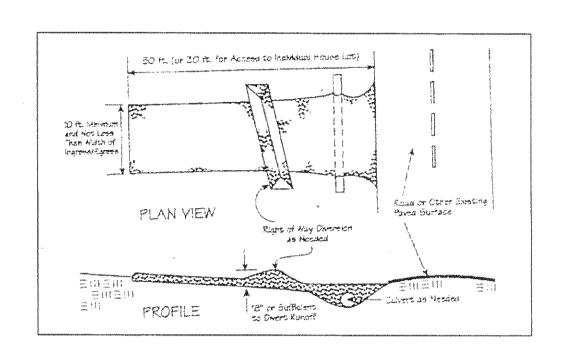

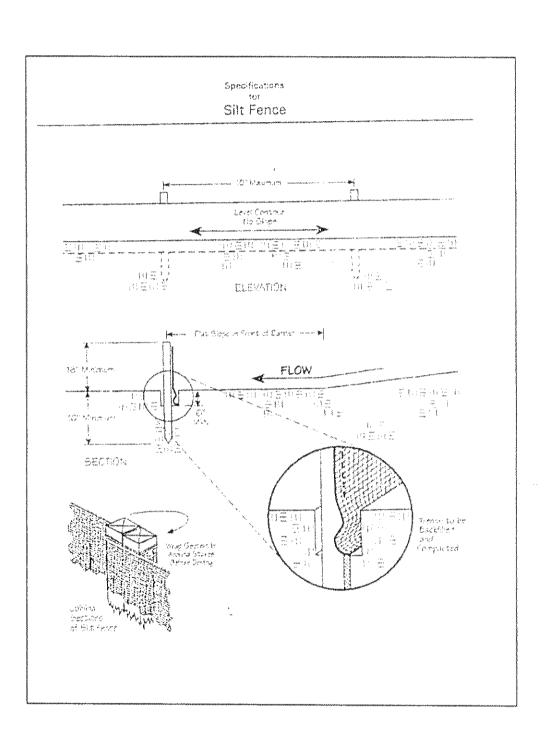

NOTE: ALL IRON PINS SET ARE 5/8" X 30" AND ARE CAPPED BABCOCK, JONES & ASSOC.

> TBM - DRILL HOLE FND ELEV - 945.19

CURVE	LENGTH	RADIUS	TANGENT	CHORD	BEARING	DELTA
C1	43.29	530.00	21.65	43.27	S04'56'38"W	04'40'46"
C2	76.80	500.00	38.47	76.72	S02°53'16"W	08*48'00"

Stormkeige Managaman, Tit-Approved to chown and/or as: JAMES R. GILLS, RE. County Drainage Engineery Lis (S Date 4/14/05

EXISTING UTILITIES NOTE:
THE SIZE AND LOCATION, BOTH HORIZONTAL AND VERTICAL
OF THE UNDERGROUND UTILITIES SHOWN HEREON, HAVE BEEN
OBTAINED BY A SEARCH OF AVAILABLE RECORDS.
VERIFICATION BY FIELD OBSERVATION HAS BEEN CONDUCTED
WHERE PRACTICAL, HOWEVER, BABCOCK, JONES AND ASSOCIATES
INC. DOES NOT GUARANTEE THE COMPLETENESS NOR ACCURACY
THEREOF.



REV NO.	DESCRIPTION	DATE	BY	CHK'D
n de la company				
CONTRACT OF THE CONTRACT OF TH				

			SHA	L.C.	215014	74CE	
6000V3	DATE	3/23/	05	MARCHINO POLICIA MARCHINO POLICIA NA PARAMENTA NA PARAMEN	ASSESSMENT SERVICES	nezeo (emerinteane) e	AND TO THE PROPERTY OF THE PRO
	DESIGN BY	Н.Ј.					
	DRAWN BY	B.P.					
	APPROVED BY	H.J.			S /I	42 E	21 ITT
	CREW CHIEF	provide provid		CONC	ORD TO		

"I, the undersigned hereby certify that this topography indicated by 6", 1' or 2'

contours, and elevations shown hereon

represent an actual field survey made by me on the 1715 day of Makest, 2005

and that the elevations were taken at appropriate intervals and that as of that date, they existed as indicated hereon."

thun The =63:13

Reg. No.

DISCHARGE ONTO A SPLASH BLOCK

FOR ANDY LONCAR S/L 42 BUTTERFLY STREET (NATURE PRESERVE NORTH SUB 1.) STATE OF OHIO LAKE COUNTY

SITE PLAN

1'' = 20'JOB NO 04-129-42

BABCOCK,	JONES	AND	ASSOCIATES,	IN(
CIVIL ENG	INEERS - SU	JRVEYOR	S - LAND PLANNERS			
PAINESVILLE OHIO 44077						