


GRAPHIC SCALE

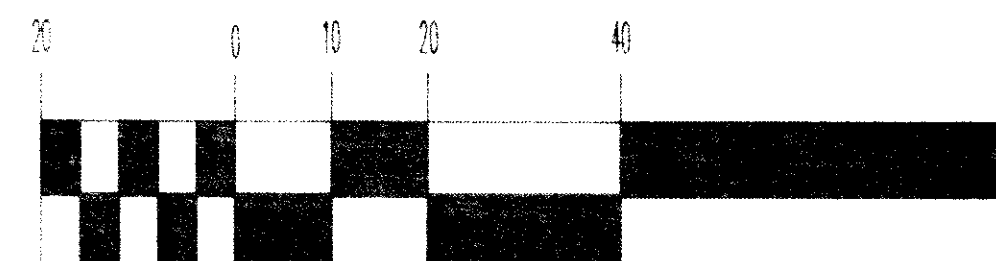

( IN FEET )


1 inch = 20 ft.

### GENERAL NOTES:

1. DRIVEWAY APRON TO BE 6" THICK
2. BENCHMARK - TOP STEM OF FIRE HYDRANT LOCATED IN FRONT OF SUBLOT No. 72, ELEV. = 696.01

### LEGEND

- EXISTING CONTOUR  
--- PROPOSED CONTOUR
- 100.00  
100.00  
--- EXISTING ELEVATION  
--- PROPOSED ELEVATION

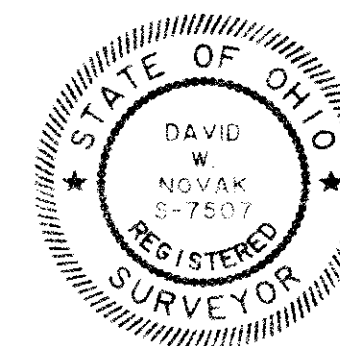

### CERTIFICATION

"I THE UNDERSIGNED HEREBY CERTIFY THAT THIS TOPOGRAPHY INDICATED BY 'I' CONTOURS AND ELEVATIONS SHOWN HEREON REPRESENTS AN ACTUAL SURVEY MADE BY ME ON THE 16th DAY OF MAY, 1996 AND THE ELEVATIONS WERE TAKEN AT APPROPRIATE INTERVALS AND AS OF THAT DAY THEY EXISTED AS INDICATED HEREON.

"I HEREBY CERTIFY THAT THIS PLAN WAS PREPARED BY ME AND IS CORRECT TO THE BEST OF MY KNOWLEDGE"


DAVID W. NOVAK, P.S. No. 7507

### PREPARED BY:

**Himebaugh and Novak**  
Surveyors and Site Consultants  
8663 Tyler Boulevard  
Mentor, Ohio 44060-4346  
(216) 974-7670, (216) 255-5900 FAX.

**SITE PLAN:** SUBLOT No. 83 RED PINE DRIVE 60' PAINESVILLE TWP.  
CEDAR GLEN No. 6, VOL. 26, PG. 29  
**PREPARED FOR:** LITTLE MOUNTAIN HOMES, INC.  
**SCALE:** 1" = 20'  
**DATE:** JUNE 17, 1996  
**DRAWN BY:** DAVID W. NOVAK

96046-83

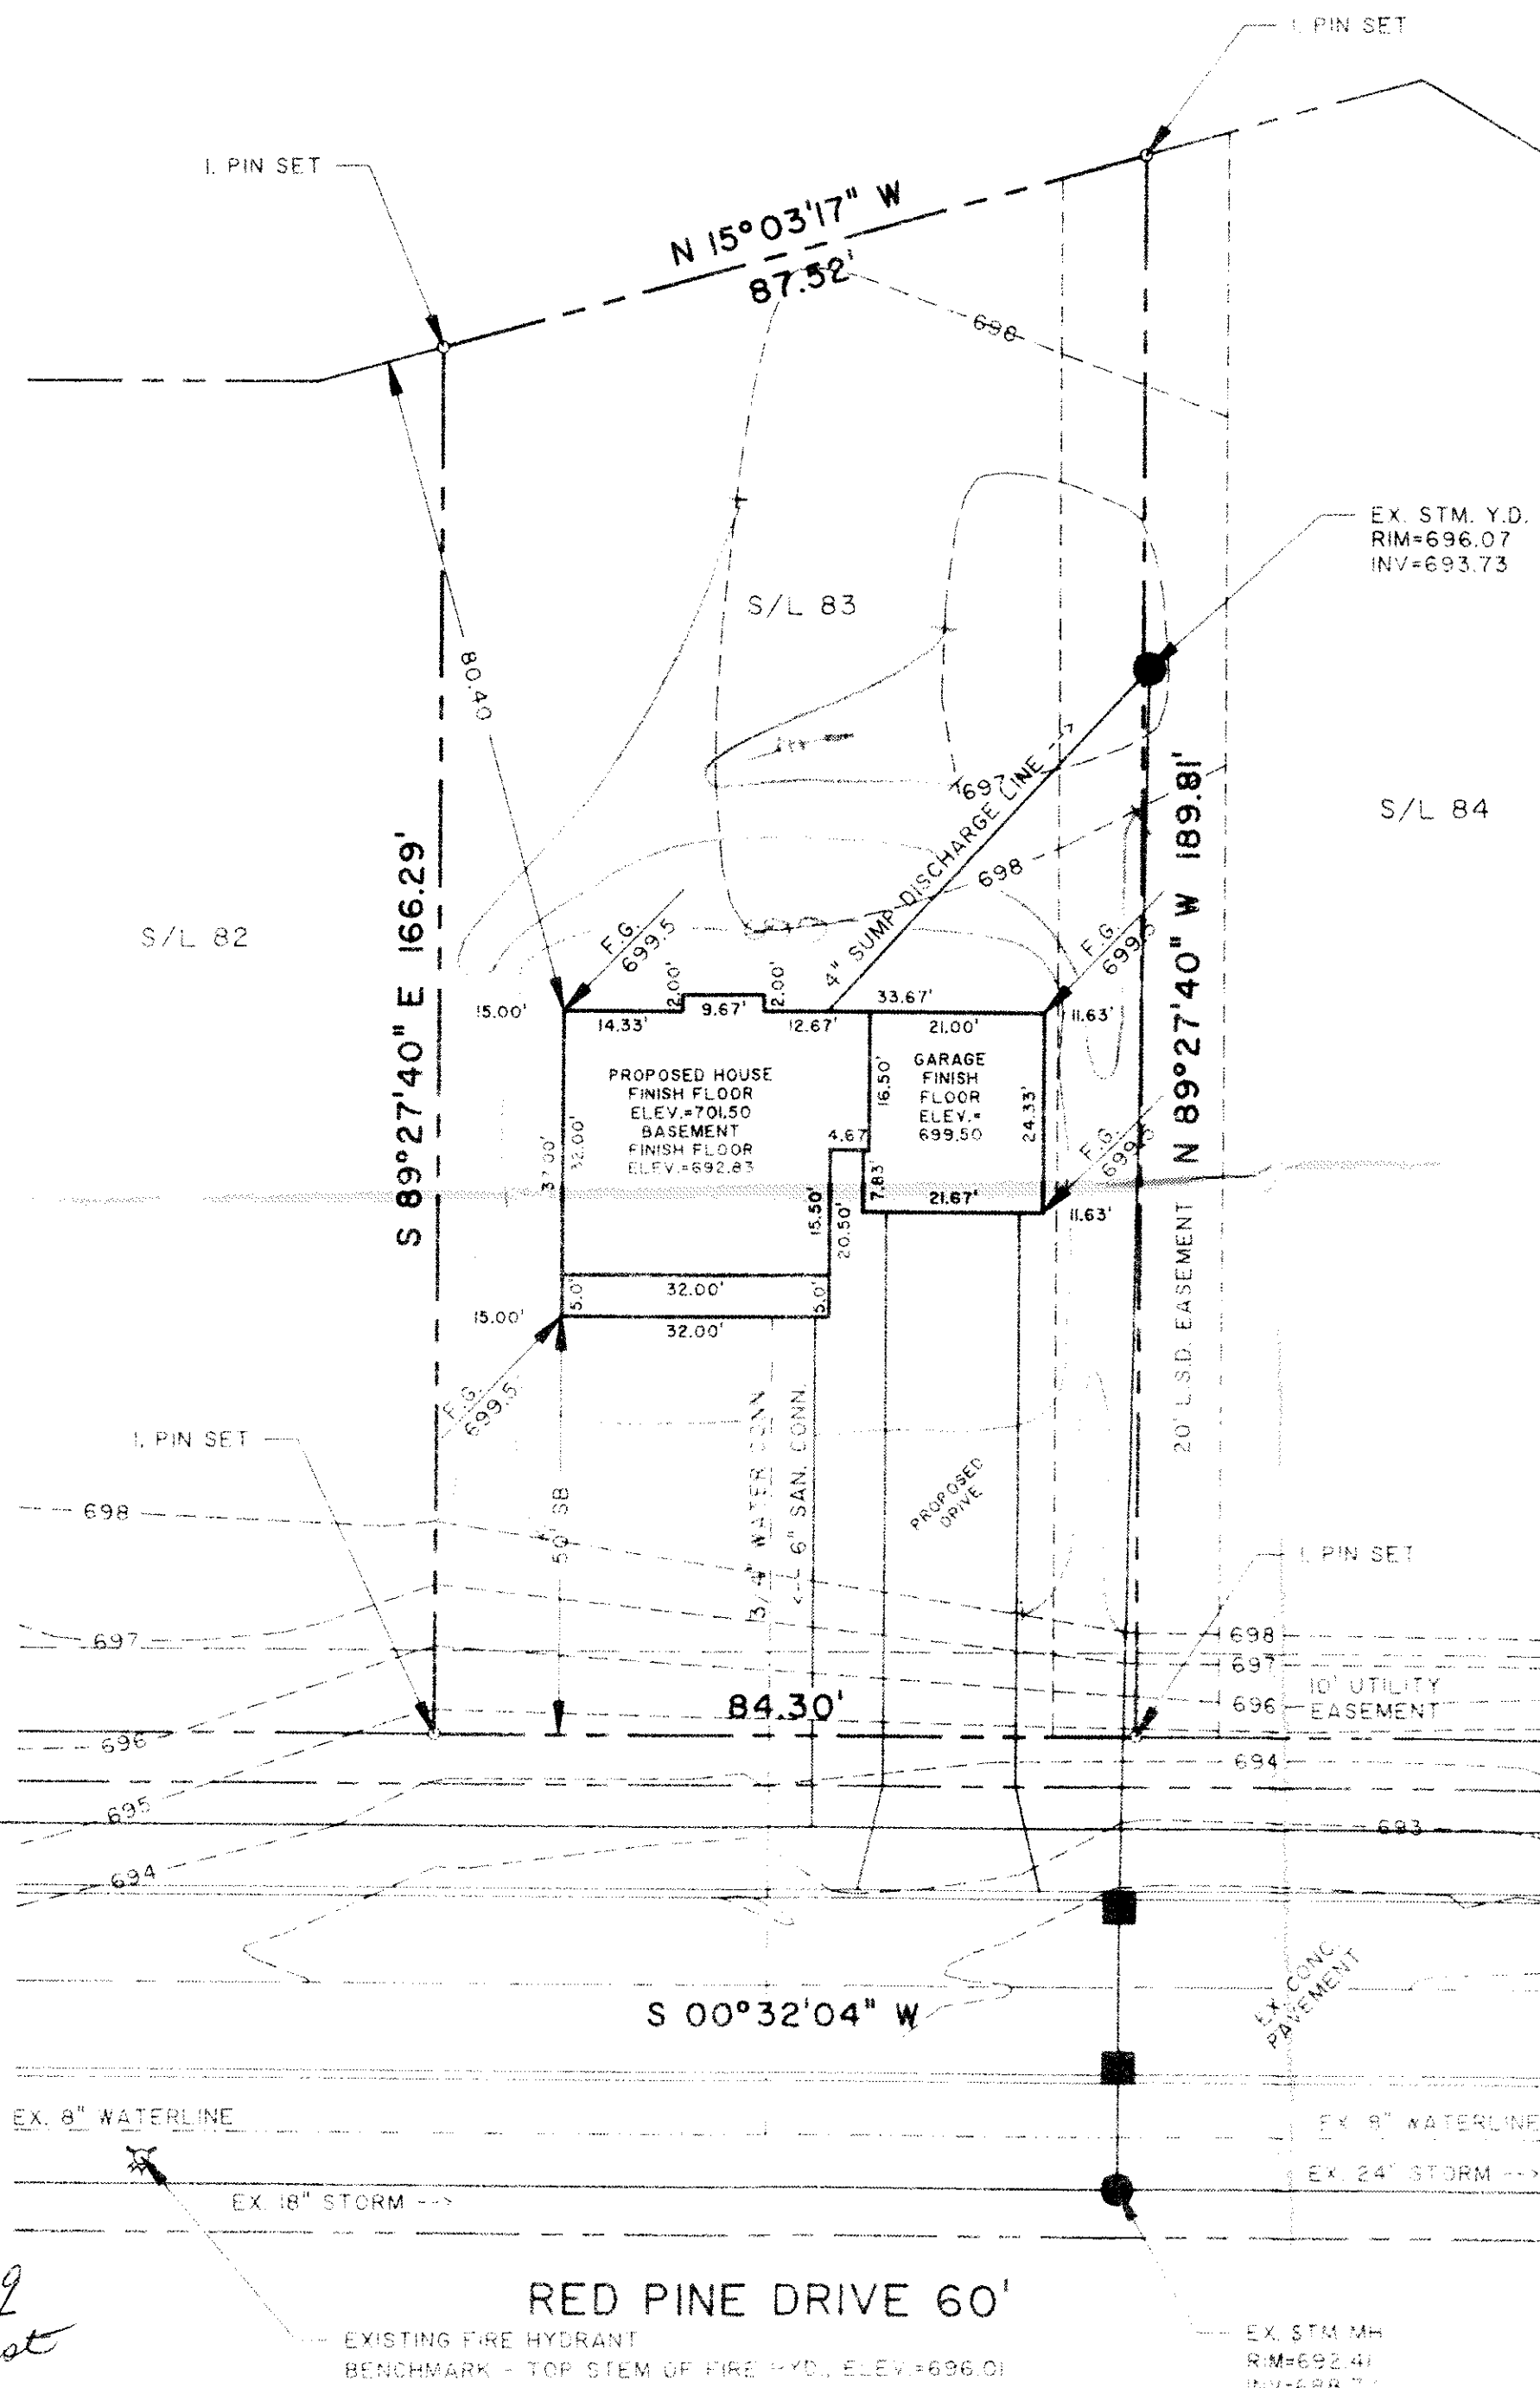

Grading Plan  
Prepared by  
THOMAS P. GILLO  
Lancaster County Engineer  
6/14/96 7:51 PM

ROOF DRAINS  
SHALL DISCHARGE  
TO SPLASH BLOCKS.

EX. SAN. MH.  
RIM=695.03  
INV=686.55

APPROVED  
PAINESVILLE TOWNSHIP  
ZONING DEPARTMENT  
#96-06-49  
DJ Rust

RED PINE DRIVE 60'  
EXISTING FIRE HYDRANT  
BENCHMARK - TOP STEM OF FIRE HYD., ELEV.=696.01

EX. STM. MH.  
RIM=692.41  
INV=688.77