

Erosion and Sediment Control Schedule

A stone access drive complete with under lying geo—textile fabric (20 feet wide and 50 feet long) for ingress and egress at the site shall be installed. This drive shall be the only entrance and exit to the site.

All silt fence shall be installed prior to any earthwork activities at the site in the locations shown on the site plan as well as along the front of any lot that slopes towards the street.

Temporary Seeding
Disturbed areas of the site that are to remain idle for more than thirty (30) days shall be properly seeded and straw mulched within seven (7) days of completion of initial grading.

Temporary seeding and mulching of a thirty (30) foot strip of the entire front of the lot shall be maintained on the site once initial grading is complete.

Stabilization of critical areas within fifty (50) feet of any stream or wetland shall be complete within two (2) days of the disturbance if the site is to remain inactive for longer than fourteen (14) days.

Mulching Straw—mulch shall be applied at a rate of 1 bale per every ten (10) feet of curb, at a width of thirty (30) feet of the entire length of the lot. Wood chips may also be used but must be spread at a minimum depth of four inches over the thirty—foot width and must be accompanied by a properly installed silt fence.

Erosion and sediment controls shall be inspected every seven (7) days or within 24 hours of a 0.5" or greater rainfall event.

Necessary repairs shall be made at this time.


All erosion and sediment control specifications, applications, and timetables are based on the descriptions and standards of The Ohio Department of Natural Resources "Rainwater and Land Development Manual" and can be found in the Lake County Erosion and Sediment Control Rules as adopted


The specified erosion and sediment control standards are the general guidelines and shall not limit the right of the county to impose, at any time, additional, more stringent requirements. Nor shall the standards limit the right of the county to waive, in writing, individual requirements.

Temporary Seeding Specifications


Seeding Dates	Species	Lb. / 1000sqft	Per Acre
March 1 to August 15	Oats Tall Fescue Annual Ryegrass	3 1 1	4 bushel 40 lb. 40 lb.
	Perenniai Ryegrass Tall Fescue Annual Ryegrass	1 1 1	40 lb. 40 lb. 40 lb.
August 16 to November 1	Rye Tall Fescue Annual Ryegrass	1 1 1	2 bushel 40 lb. 40 lb.
	Wheat Tall Fescue Annual Ryegrass	1 3 1 1 1 1 1 1 1 1 1 1 1 1 1 1 1 1 1 1	40 lb. 40 lb. 40 lb.
	Perennial Ryegrass Tall Fescue Annual Ryegrass	1 1	40 lb. 40 lb. 40 lb.
November 1 to Spring Seeding	Use mulch only, soddin	g practices or dorma	int seeding

Note: other approved seed species may be substituted.

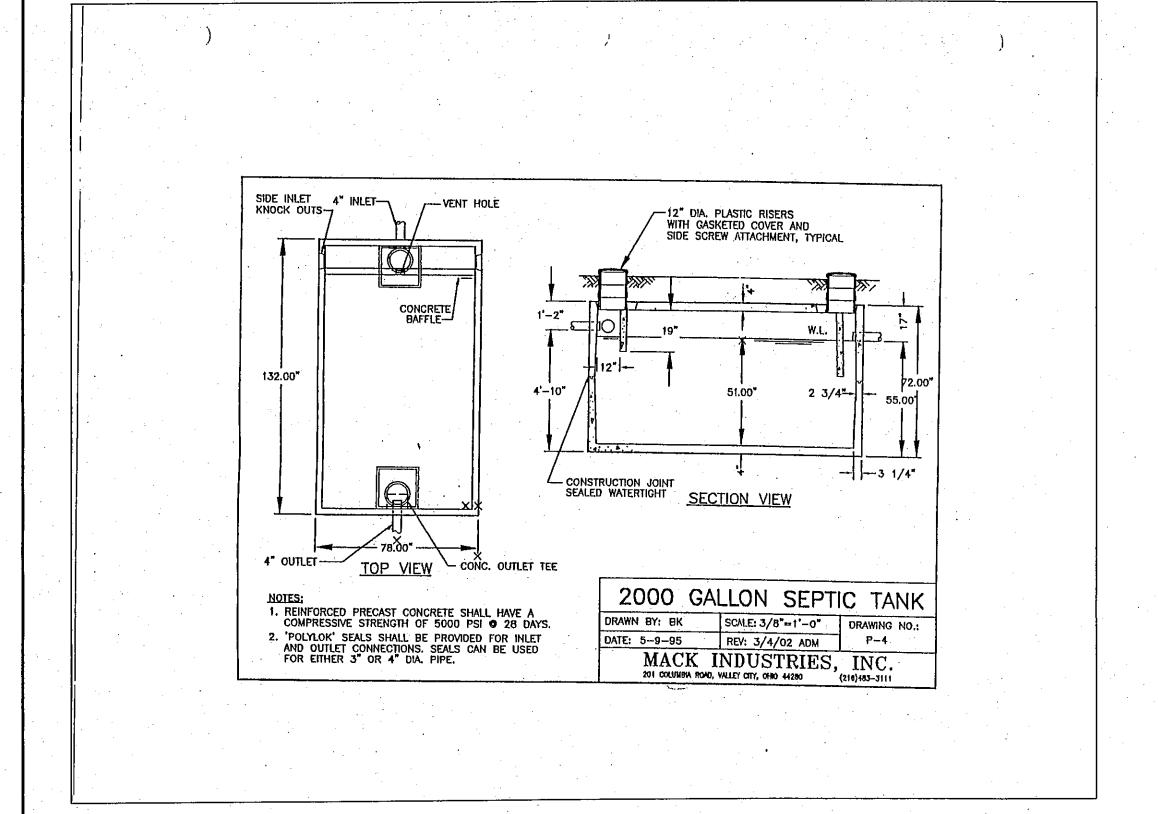

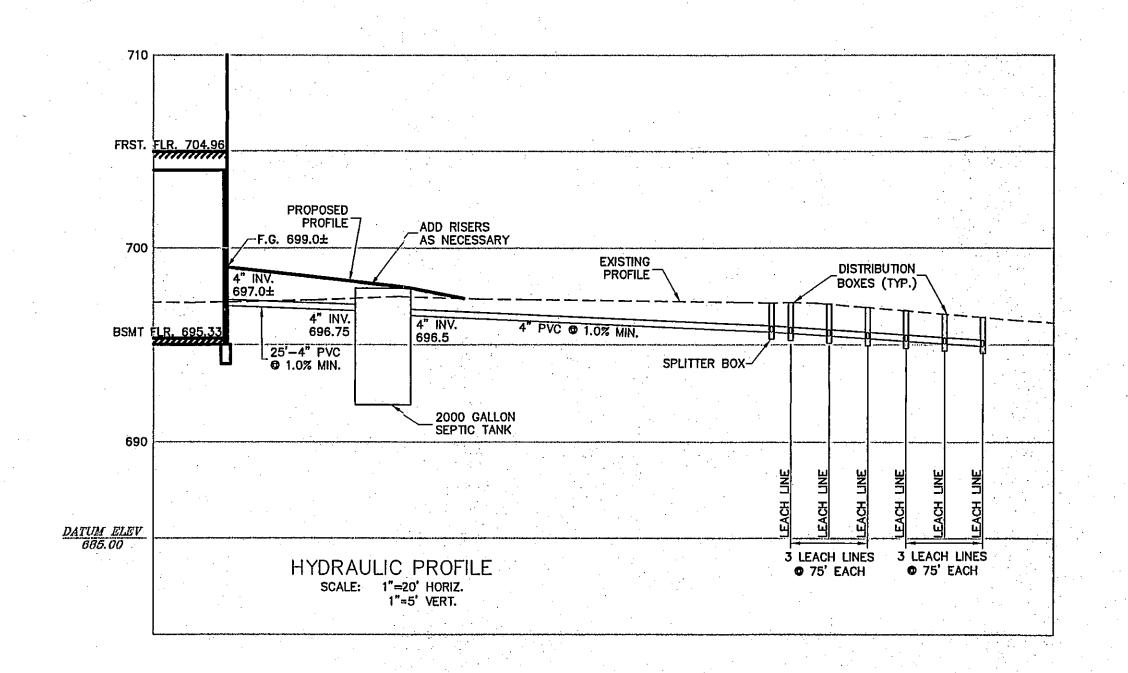

THE KAUFMAN RESIDENCE MIDDLE RIDGE ROAD

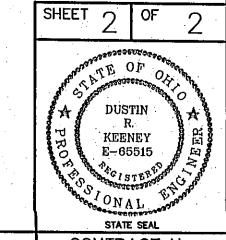

CONTRACT No. 05862

DATE: 12/06/05 SCALE: HOR. <u>1"=20"</u> VERT. 1"=0'

MADISON TOWNSHIP - LAKE COUNTY - OHIO

POLARIS ENGINEERING & SURVEYING, INC. 34600 CHARDON ROAD — SUITE D WLLOUGHBY HILLS, OHIO 44094 (440) 944-4433 (440) 944-3722 (Fax) www.polaris-es.com

FILENAME: Site Plan TAB: Site Plan-01 DRAWN: KTH FIELD: xxxx