


Seeding Dates	Species	Lb./1,000 ft. ²	Per Ac.
March 1 to August 15	Oats Tall Fescue Annual Ryegrass	3 · 1	4 bushel 40 lb. 40 lb.
	Perennial Ryegrass Tall Fescue Annual Ryegrass	1 1 1	40 lb. 40 lb. 40 lb.
August 16 to November 1	Rye Tell Fescus Annual Ryegrass	3 1 1	2 bushel 40 lb. 40 lb.
	Wheat Tall Fescue Annual Ryegrass	3 1 1	2 bushel 40 lb. 40 lb.
	Perennial Ryegrass Tall Fescue Annual Ryegrass	1 1 1	40 lb. 40 lb. 40 lb.

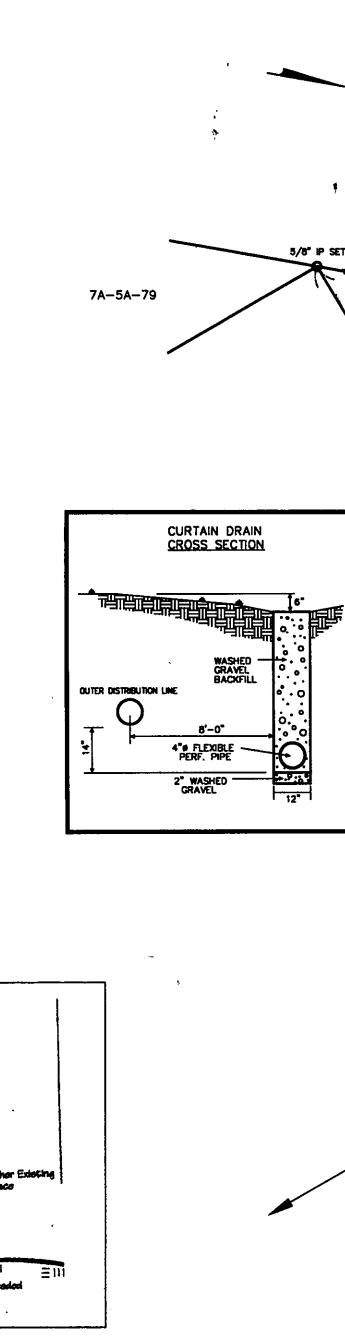

"AS BUILT" CERTIFICATION

I, HEREBY CERTIFY THAT THE CIRCLED GRADES ARE EXISTING
FINISH GRADES CHECKED IN THE FIELD ON THE PEST OF MY KNOWLEDGE AND BELIEF.

WHO SH'S

NOTE: ALL IRON PINS SET ARE 5/8" X 30" AND ARE CAPPED BABCOCK, JONES & ASSOC.

EXIST HSE FF 995.78

7A-5A-14



2). DRIP MOUND AND DUPLICATION AREAS HAVE BEEN MARKED OFF TO PROHIBIT DISTURBANCE OF AREA DURING HOME CONSTRUCTION.

3). INSTALLER TO PROVIDE AS-BUILT OF DRIP SYSTEM TO HOME OWNER AND LAKE COUNTY HEALTH DEPARTMENT.

4). SEPTIC APPROVAL IS GOOD FOR A 1 YEAR PERIOD.


5). SWITCHES, CONTROLS, ALARMS & ELECTRICAL COMPONENTS SHALL BE UL OR CSA LISTED PRODUCTS, NATIONAL ELECTRIC CODE 3701-29-11-E-G. 6). AN EFFECTIVE SAND FILL MATERIAL SHALL BE AN EFFECTIVE SIZE IN THE RANGE OF 0.15 MM TO 0.30 MM. A

UNIFORMITY COEFFICIENT IN THE RANGE OF 4-6. NO MORE THAN 20% BY WEIGHT IS GRAVEL GREATER THAN 2 MM AND NO MORE 5% BY WEIGHT IS SILT AND CLAY LESS THAN 0.053 MM PER 3701-29-13.2 (2).

7). FOR THE START-UP, CONTRACTOR SHALL MEASURE DOSING FLOW RATE, FLUSHING FLOW RATE AND A METER READING FOR THE LAKE COUNTY HEALTH DEPARTMENT.

8). HOME OWNER SHALL CONTRACT WITH A CERTIFIED SERVICEPROVIDER FOR MAINTENANCE AND OPERATION OF DRIP SYSTEM, INSPECTION OF SYSTEM WILL BE BY CERTIFIED SERVICE PROVIDER AND REPORTS ARE TO BE SUBMITTED TO THE LAKE COUNTY HEALTH DEPARTMENT.

NOT TO SCALE

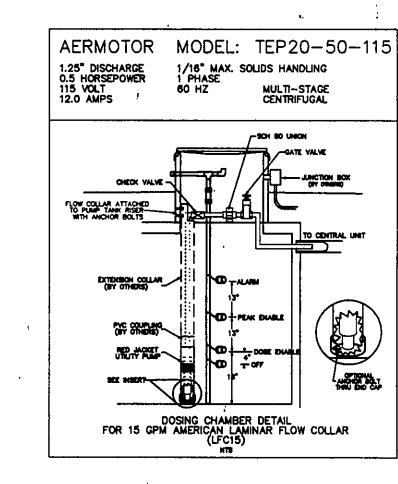

Erosion and Sediment Control Schedule

Ingress-Egress

A stone access drive complete with under lying geo—textile fabric (20 feet wide and 50 feet long) for ingress and egress at the site shall be installed. This drive shall be the only entrance and exit to the site.

Silt Fence
A silt fence shall be installed prior to any earthwork activities at the site in the locations shown on the site plan as well as along the front of any lot that slopes towards the street.

Temporary Seeding
Disturbed areas of the site that are to remain idle for more than twenty-one(21) days shall be properly seeded and straw mulched within seven(7) days of completion of intitial grading. Temporary seeding and mulching as a thirty(30) foot strip of the entire front of the lot shall be maintained on the site once initial grading is complete.

Stabilization of critical areas within fifty(50) feet of any stream or wetland shall be complete within two(2) days of the disturbance if the site is to remain inactive for longer than fourteen(14) days.

Mulching
Straw-mulch shall be applied at a rate of 1 bale per every ten (10) feet of curb, at a width of thirty(30) feet to the entire length of the lot. Wood chips may also be used but must be spread at a minimum depth of four inches over the thirty-foot width and must be accompanied by a properly installed silt

<u>Maintenance</u>

Erosion and sediment controls shall be inspected every seven(7) days or within 24 hours of a 0.5" or greater rainfall event. Necessary repairs shall be made at this time.

> Stormwater Management Plan
> Approved as shown and/or noted JAMES R. GILLS, P.E. County Drainage Engineer

"I, the undersigned hereby certify that this topography indicated by 6", 1' or 2' contours, and elevations shown hereon represent an actual field survey made by me on the place of the place

TBM - 5/8" IP SET REF POINT

ELEV - 989.07

STATE OF OHIO

EXISTING UTILITIES NOTE:
THE SIZE AND LOCATION, BOTH HORIZONTAL AND VERTICAL
OF THE UNDERGROUND UTILITIES SHOWN HEREON, HAVE BEEN
OBTAINED BY A SEARCH OF AVAILABLE RECORDS.
VERIFICATION BY FIELD OBSERVATION HAS BEEN CONDUCTED
WHERE PRACTICAL, HOWEVER, BABCOCK, JONES AND ASSOCIATES
INC. DOES NOT GUARANTEE THE COMPLETENESS NOR ACCURACY
THEREOF.



REV NO.	DESCRIPTION	DATE	BY	CHICD
1	(Levisa) 202 Stream ILey	12/26/07	1: :===	1-1-19
1 17	A 11 11 11 11 11 11 11 11 11 11 11 11 11	12/27/07	17	15
3	-1 4 4 4	118/08	177	117
4	PLENISED PERLC. HEATH GEOT	1/11/08	177	119
5	AR- BYLLT REDISED SETBICK	7/30/08	HT	rfs

BABCOCK, JONES AND ASSOCIATES, INC

GRAPHIC SCALE

(IN FEET)

1 inch = 30 ft. 4

7A-5A-18

74-58-77

<u> </u>	···
DATE	12/21/07
DESIGN BY	H.J.
DRAWN BY	B.P.
APPROVED BY	H.J.

W.B.

LCR = 2.7

SITE PLAN JACK WATERWASH

PAINESVILLE WARREN ROAD (P.P.# 7A-5A-77) LAKE COUNTY LEROY TOWNSHIP

1"=30' JOB NO 00-286-8 SHEET

CIVIL ENGINEERS - SURVEYORS - LAND PLANNERS PAINESVILLE OHIO 44077