

GRAPHIC SCALE

(IN FEET)
1 inch = 20 ft.

NOTE: ZONE 2 IS
IDENTICAL IN SIZE

AIR RELEASE & CHECK VALVE (TYP.)

AIR RELEASE & CHECK VALVE
AT HIGHEST ELEVATION OF EACH
RETURN MANIFOLD BEFORE THE
COMMON RETURN.


EACH LATERAL WILL FEED FROM THE
LOWER RUN IN THE LATERAL AND RETURN
FROM THE HIGHER RUN IN THE LATERAL.

Temporary Seeding Species Selection			
Seeding Dates	Species	Lb./1,000 ft ²	Per Ac
March 1 to August 15	Oats	3	4 bushel
	Tall Fescue	1	40 lb.
	Annual Ryegrass	1	40 lb.
	Perennial Ryegrass	1	40 lb.
	Tall Fescue	1	40 lb.
August 16 to November 1	Rye	3	2 bushel
	Tall Fescue	1	40 lb.
	Annual Ryegrass	1	40 lb.
	Wheat	3	2 bushel
	Tall Fescue	1	40 lb.
November 1 to Spring Seeding	Perennial Ryegrass	1	40 lb.
	Tall Fescue	1	40 lb.
	Annual Ryegrass	1	40 lb.
	Use mulch only, sodding practices or dormant seeding		
	Note: Other approved seed species may be substituted.		

AERMOTOR MODEL: TEP20-50-115

1.25" DISCHARGE
0.5 HORSEPOWER
115 VOLT
12.0 AMPS

1/16" MAX. SOLIDS HANDLING
1 PHASE
60 HZ
MULTI-STAGE
CENTRIFUGAL

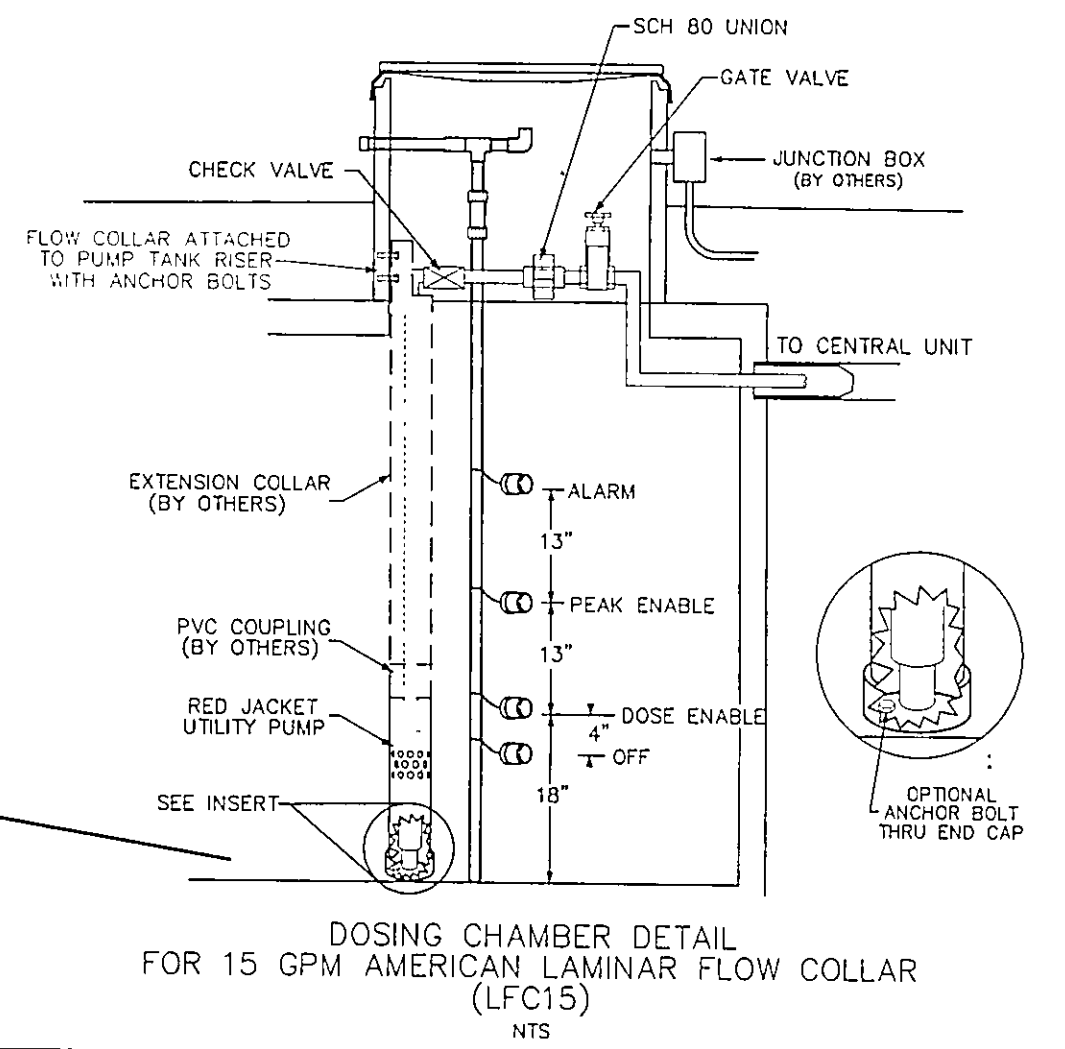

Erosion and Sediment Control Schedule

Ingress-Egress
A stone access drive complete with under lying geo-textile fabric (20 feet wide and 50 feet long) for ingress and egress at the site shall be installed. This drive shall be the only entrance and exit to the site.

Silt Fence
A silt fence shall be installed prior to any earthwork activities at the site in the locations shown on the site plan as well as along the front of any lot that slopes towards the street.

Temporary Seeding
Disturbed areas of the site that are to remain idle for more than twenty-one(21) days shall be properly seeded and straw mulched within seven(7) days of completion of initial grading. Temporary seeding and mulching on a thirty(30) foot strip of the entire front of the lot shall be maintained on the site once initial grading is complete.

Stabilization of critical areas within fifty(50) feet of any stream or wetland shall be complete within two(2) days of the disturbance if the site is to remain inactive for longer than fourteen(14) days.

Mulching
Straw-mulch shall be applied at a rate of 1 bale per every ten (10) feet of curb, at a width of thirty(30) feet to the entire length of the lot. Wood chips may also be used but must be spread at a minimum depth of four inches over the thirty-foot width and must be accompanied by a properly installed silt fence.


Maintenance
Erosion and sediment controls shall be inspected every seven(7) days or within 24 hours of a 0.5" or greater rainfall event. Necessary repairs shall be made at this time.

TBM - T.S.F.H.
ELEV - 812.59

Stormwater Management Plan
Approved as shown and/or noted
JAMES R. GILLS, P.E.
County Drainage Engineer

By L.S. Date 5/26/09

EXISTING UTILITIES NOTE
THE SIZE AND LOCATION, BOTH HORIZONTAL AND VERTICAL OF THE UNDERGROUND UTILITIES SHOWN HEREON, HAVE BEEN OBTAINED BY A SEARCH OF AVAILABLE RECORDS. VERIFICATION BY FIELD OBSERVATION HAS BEEN CONDUCTED WHERE PRACTICAL, HOWEVER, BABCOCK, JONES AND ASSOCIATES, INC. DOES NOT GUARANTEE THE COMPLETENESS NOR ACCURACY THEREOF.

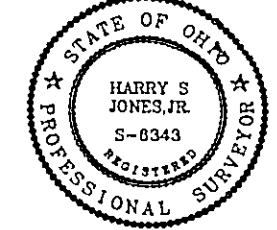

BARRISTER'S COURT - 50'

LLR = 3.3 360/109 = 360 GPD
360
3.3 = 109'

"I CERTIFY THIS SEWAGE SYSTEM DESIGN MEETS THE MINIMUM REQUIREMENTS ESTABLISHED BY THE LCGHD IN THE HSTS GUIDANCE MANUAL, AND THE REQUIREMENTS AND RECOMMENDATIONS OF THE SYSTEM MANUFACTURER."

Harry Jones #6343
Name Reg. No.

SURVEYOR CERTIFICATION

THIS PLAT REPRESENTS A SURVEY WHICH MEETS STANDARDS FOR A BOUNDARY SURVEY IN THE STATE OF OHIO AS SPECIFIED IN THE ADMINISTRATIVE CODE CHAPTER 4733-37

SURVEYED ON April 30, 2009 BY Harry Jones UNDER THE SUPERVISION OF Harry Jones, P.S. # 6343, ALL IRON PINS SHOWN HEREON WERE EITHER FOUND OR SET AS NOTED.

Harry Jones P.S. # 6343 DATE: 5/7/09

THE TOPOGRAPHY, INDICATED BY 1' CONTOURS, AND ELEVATIONS SHOWN HEREON REPRESENT AN ACTUAL FIELD SURVEY MADE BY Harry Jones ON 4/30/09. THE ELEVATIONS WERE TAKEN AT APPROPRIATE INTERVALS AND AS OF THE ABOVE DATE THEY EXISTED AS INDICATED HEREON.

Harry Jones P.S. # 6343 DATE: 5/7/09

DRIP DISTRIBUTION PLAN SUBMITTAL SHEET

CURVE	LENGTH	RADIUS	TANGENT	CHORD	BEARING	DELTA
C1	700.01	2000.00	353.62	696.44	N79°50'38"E	20°03'13"
C2	320.77	2025.00	160.72	320.44	N80°02'55"E	09°04'33"

Drip distribution area has been field verified and protected with marking tape
Plans submitted to LCGHD and meet design criteria
Hydraulic calculations verified and accurate

Date 5-14-9 Doyle
Time 5-14-9 Doyle
Hydraulic calculations verified and accurate 5-14-9 Doyle



BABCOCK, JONES AND ASSOCIATES, INC
CIVIL ENGINEERS - SURVEYORS - LAND PLANNERS
PAINESVILLE OHIO 44077

DATE	5/6/09
DESIGN BY	H.J.
DRAWN BY	B.P.
APPROVED BY	H.J.
CREW CHIEF	R.B.

SITE PLAN
FOR
KERN BUILDING INC.

S/L 10 BARRISTER'S COURT (BARRISTER'S COURT SUBDIVISION)
CITY OF KIRTLAND LAKE COUNTY STATE OF OHIO

SCALE	1"=20'
JOB NO	04-149-10
SHEET	OF
1	2