Erosion and Sediment Control Schedule

Ingress—Egress
A stone access drive complete with under lying geo—textile fabric (20 feet wide and 50 feet long) for ingress and egress at the site shall be installed. This drive shall be the only entrance and exit to the site.

Silt Fence
A silt fence shall be installed prior to any earthwork activities at the site in the locations shown on the site plan as well as along the front of any lot that slopes towards the street.

Temporary Seeding
Disturbed areas of the site that are to remain idle for more than twenty—one(21) days shall be properly seeded and straw mulched within seven(7) days of completion of intitial grading.


Temporary seeding and mulching as a thirty(30) fost strip of the entire front of the lot shall be maintained on the site once initial grading is complete.

Stabilization of critical areas within fifty(50) feet of any stream or wetland shall be complete within two(2) days of the disturbance if the site is to remain inactive for longer than fourteen(14) days.


Mulching
Straw—mulch shall be applied at a rate of 1 bale per every ten
(10) feet of curb, at a width of thirty(30) feet to the entire
length of the lot. Wood chips may also be used but must be
spread at a minimum depth of four inches over the thirty—foot
width and must be accompanied by a properly installed silt


Erosion and sediment controls shall be inspected every seven(7) days or within 24 hours of a 0.5" or greater rainfall event.


Necessary repairs shall be made at this time.

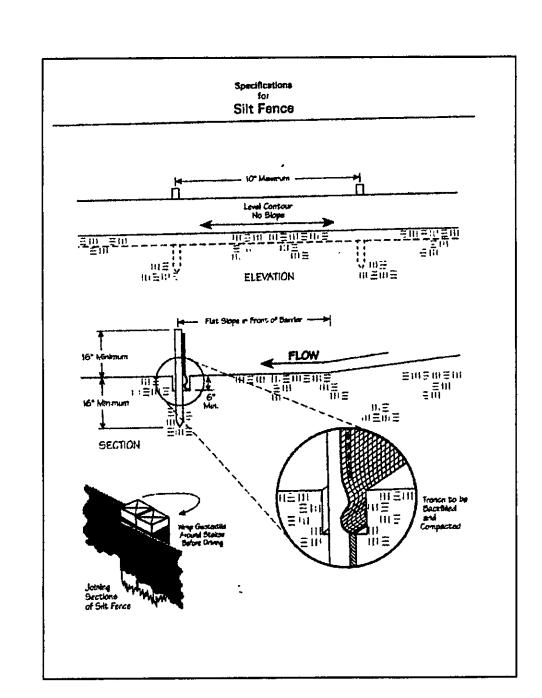

Seeding Dates	Species	Lb./1,000 ft. ²	Per Ac.
March 1 to August 15	Oats	3 ·	4 bushel
	Tail Fescue	1	40 lb.
	Annual Ryagrass	1	40 lb.
	Perennial Ryegrass	1	40 lb.
	Tall Feacue	1	40 lb.
	Annual Ryegrass	1	40 lb.
August 16 to November 1	Rye	3	2 bushel
	Tall Fescue	1	40 lb.
	Annual Ryegrass	1	40 lb.
	Wheat	3	2 bushel
	Tall Fescue	1	40 lb.
	Annual Ryegrass	1	40 lb.
	Perennial Ryegrass	1	40 lb.
	Tali Fescus	1	40 lb.
	Annual Ryegrass	1 /	40 lb.

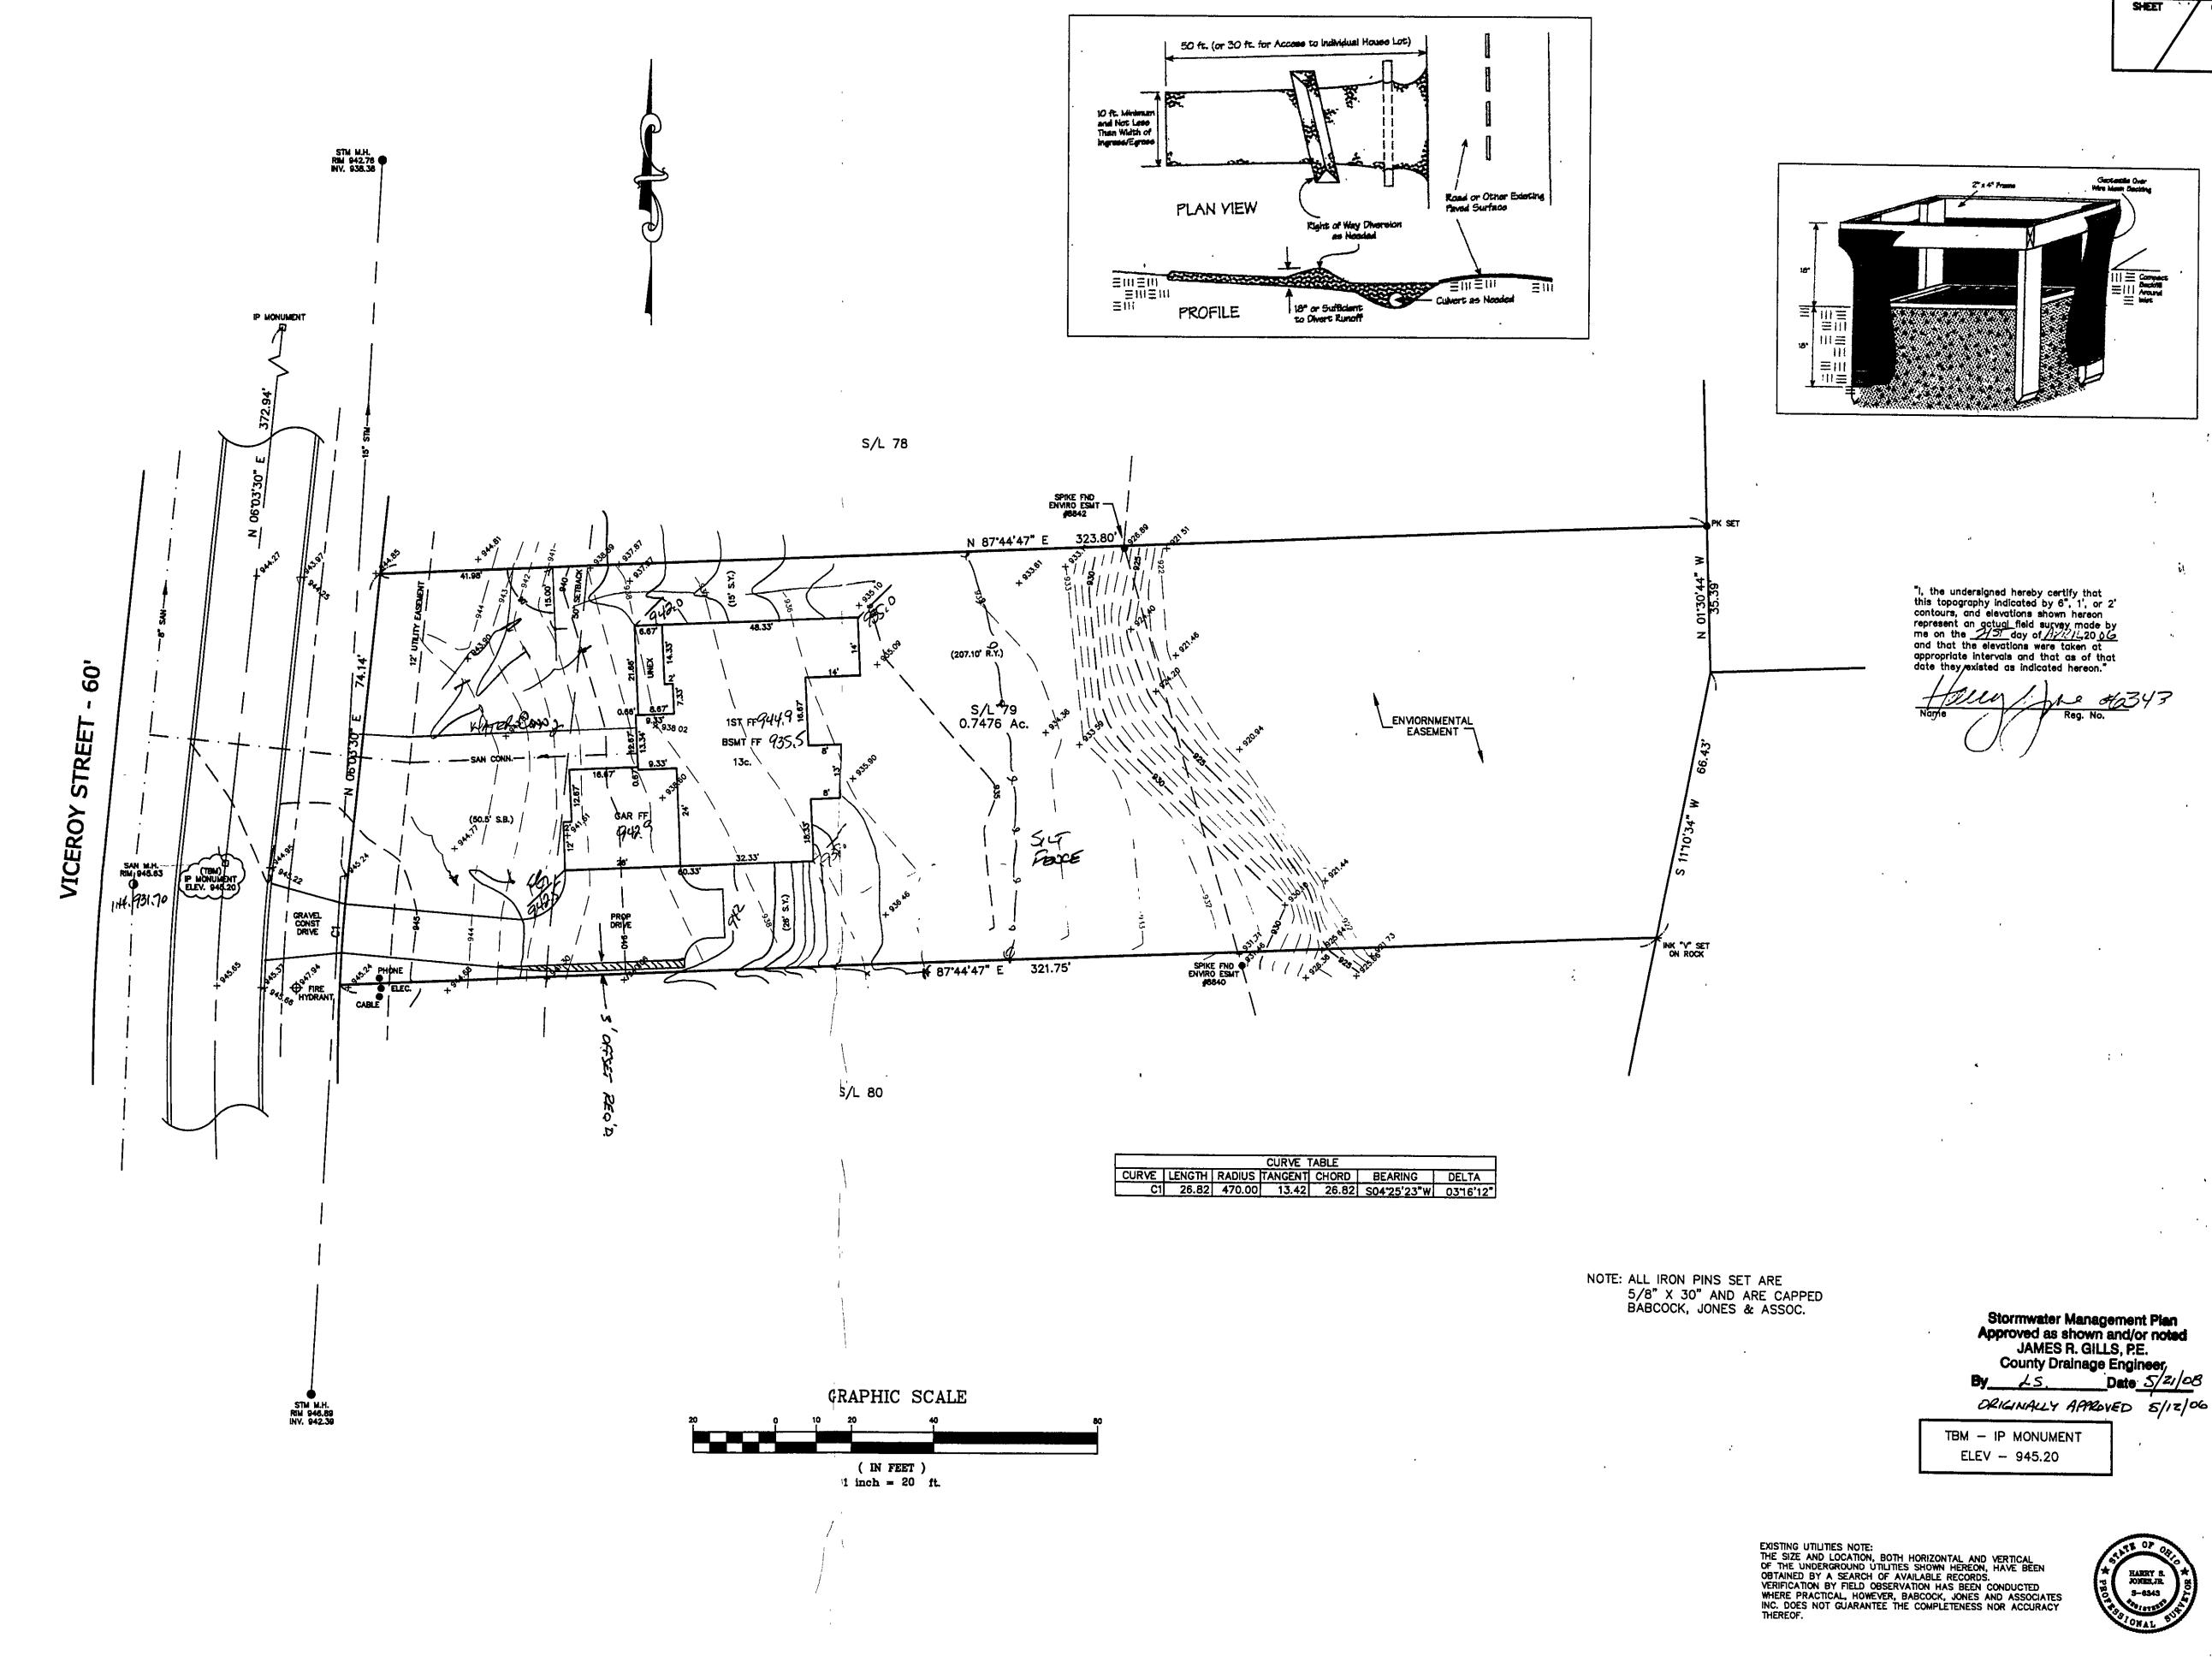

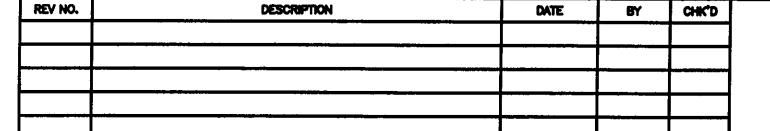


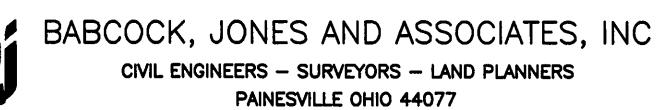

DATE	5/10/06	
DESIGN BY	H.J.	
DRAWN BY	B.P.	
APPROVED BY	H.J.	0 / 70 14055
CREW CHIEF	E.H.	S/L 79 VICERO CONCORD TOWNSHIP

SITE PLAN SHAMROCK CONSTRUCTION

S/L 79 VICEROY STREET (NATURE PRESERVE NORTH 2 SUB) STATE OF OHIO LAKE COUNTY

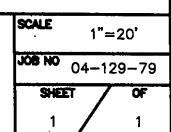

Erosion and Sediment Control Schedule

Ingress—Egress
A stone access drive complete with under lying geo—textile fabric (20 feet wide and 50 feet long) for ingress and egress at the site shall be installed. This drive shall be the only entrance and exit to the site.

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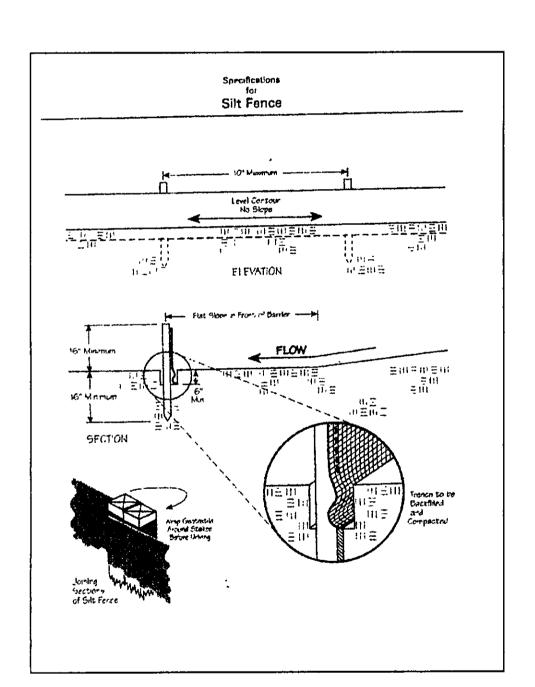
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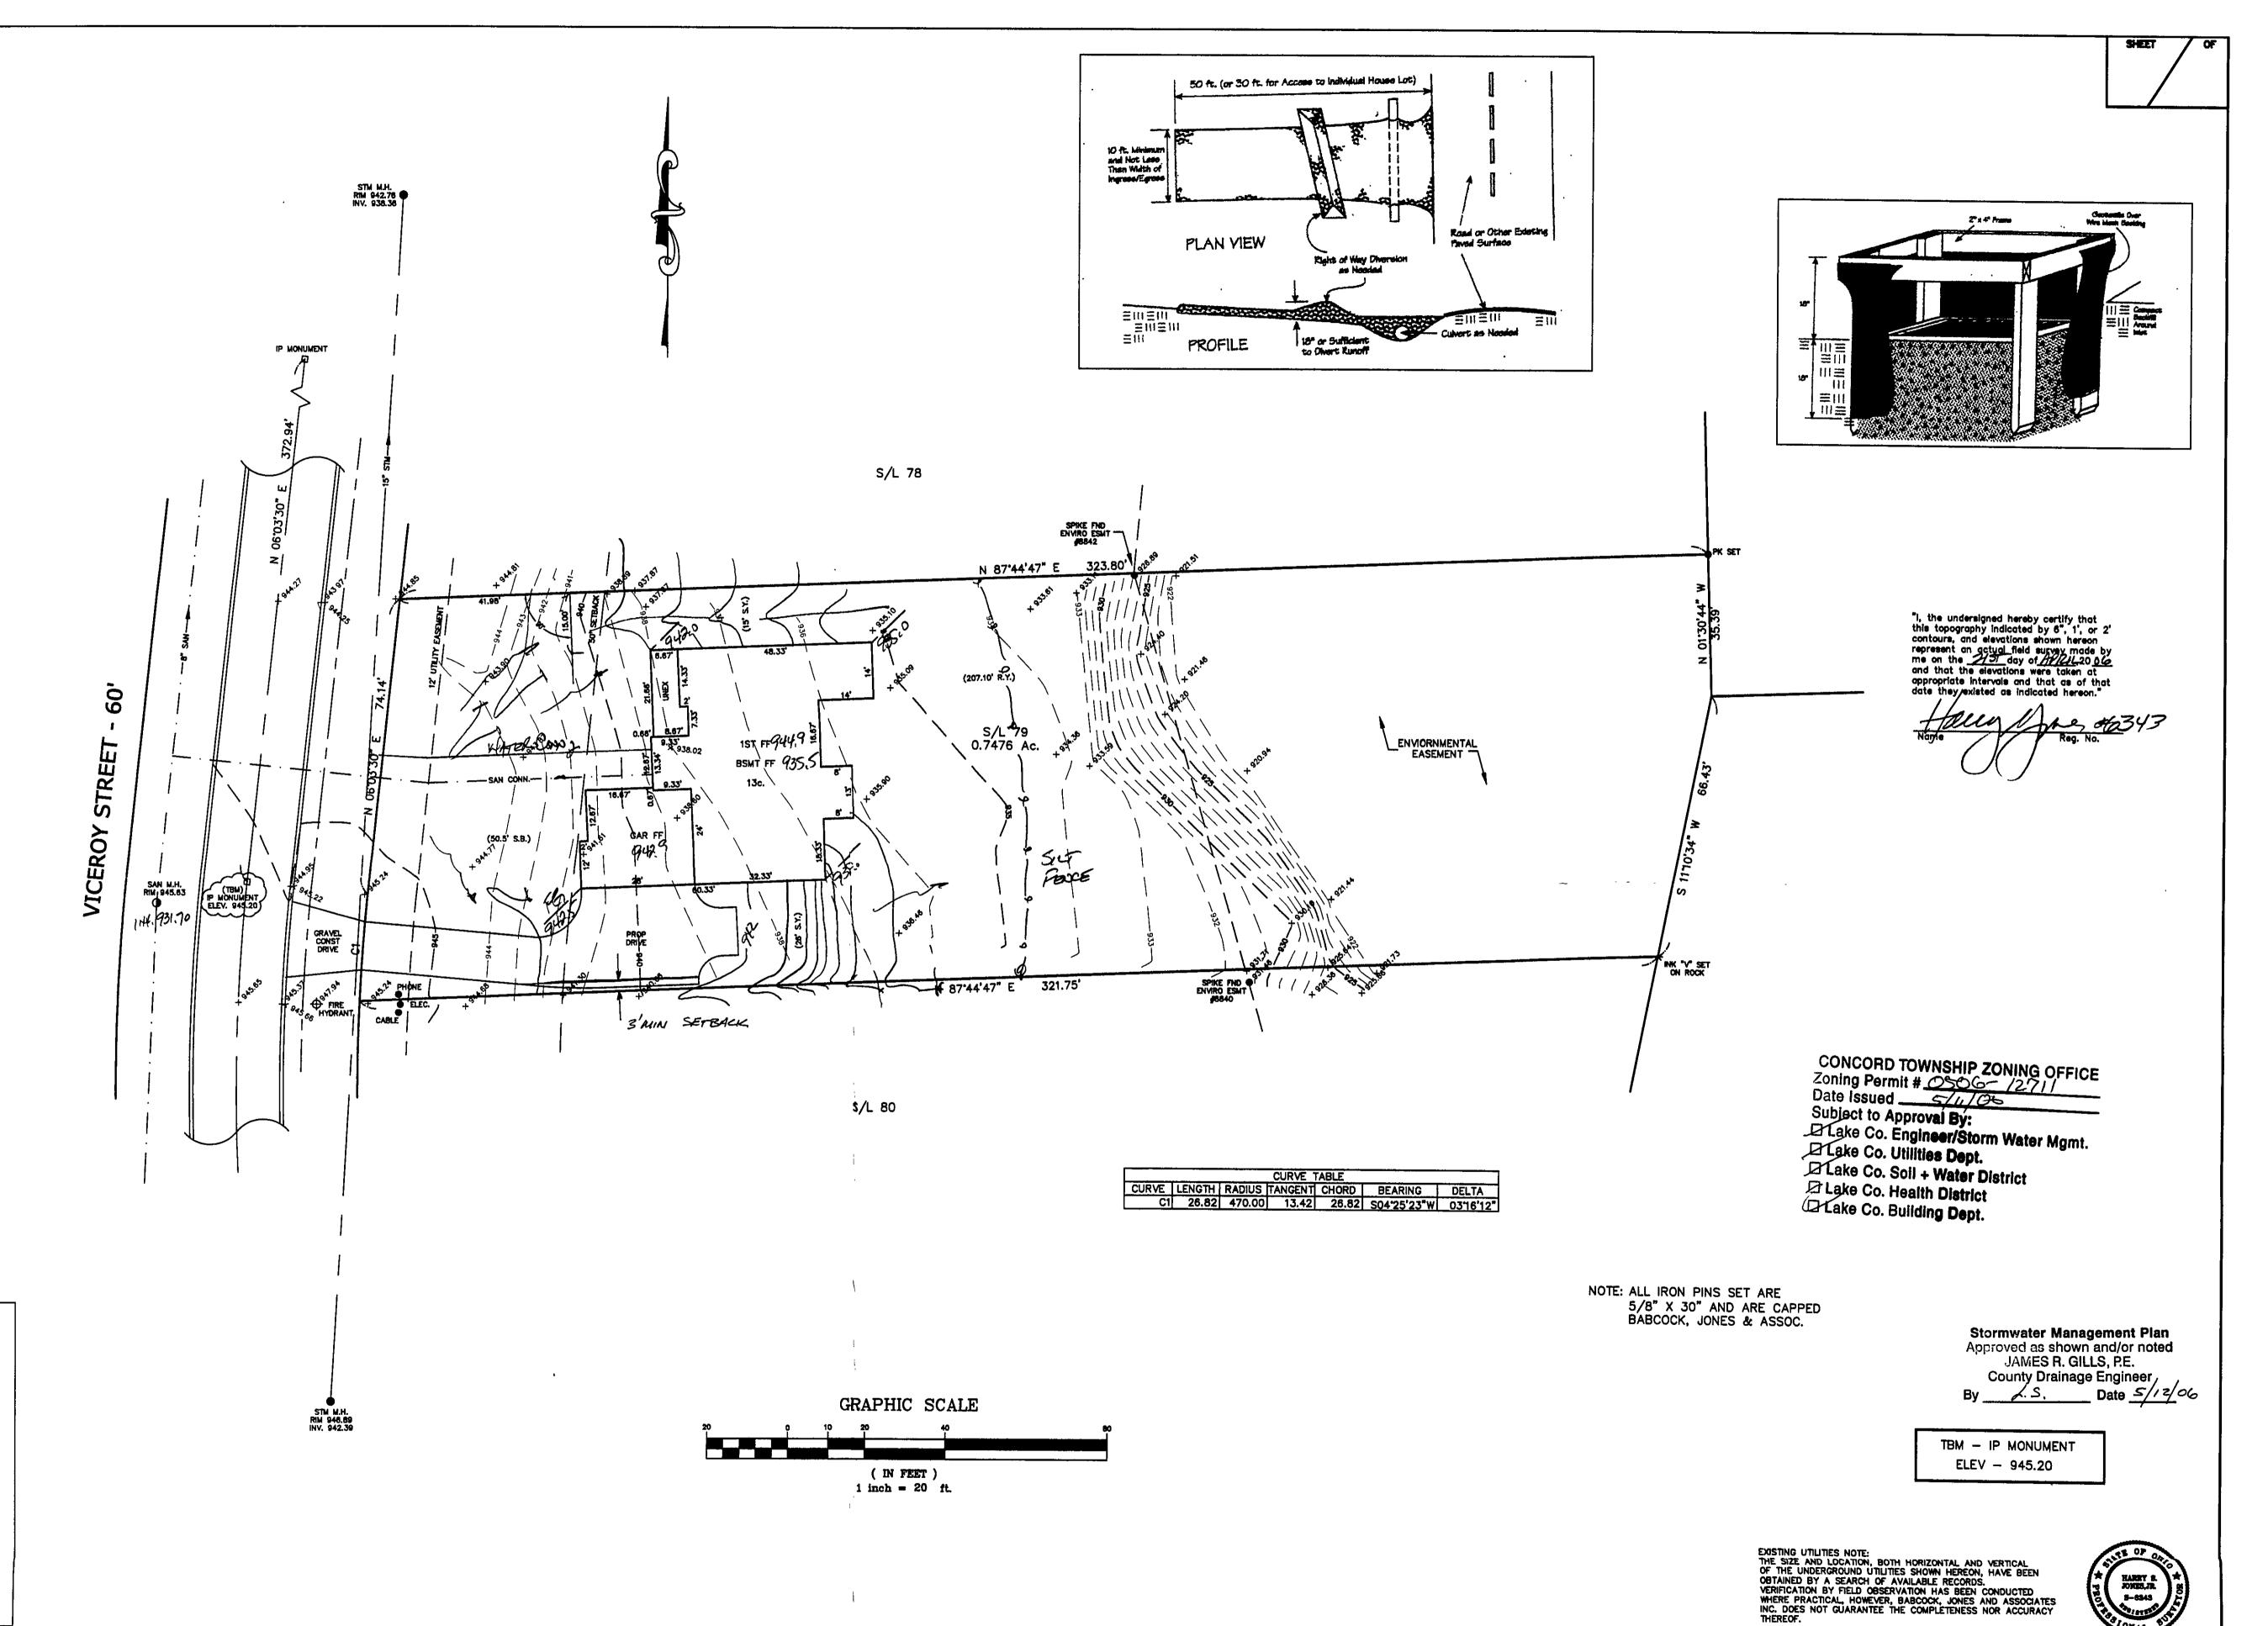
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Seeding Dates	Species	Lb./1,000 ft. ²	Per Ac.
March 1 to August 15	Oats	з .	4 bushel
	Tall Fescue	1	40 lb.
	Annual Ryegrass	1	40 lb.
	Perennial Ryegrass	1	40 lb.
	Tall Fescue	1	40 lb.
	Annual Ryegrass	1	40 lb.
August 16 to November 1	Rye	3	2 bushel
	Tall Fescue	1	40 lb.
	Annual Ryegrass	1	40 lb.
	Wheat	3	2 bushel
	Tall Fescue	1	40 lb
	Annual Ryegrass	1	40 lb.
	Perennial Ryegrass	1	40 lb.
	Tall Fescue	1	40 lb.
	Annual Ryegrass	1 1	40 lb.



REV NO. DESCRIPTION BY CHK'D



BABCOCK, JONES AND ASSOCIATES, INC CIVIL ENGINEERS - SURVEYORS - LAND PLANNERS

PAINESVILLE OHIO 44077

APPROVED BY

5/10/06

B.P.

SITE PLAN SHAMROCK CONSTRUCTION

CONCORD TOWNSHIP

S/L 79 VICEROY STREET (NATURE PRESERVE NORTH 2 SUB) STATE OF OHIO LAKE COUNTY

1"=20' JOB NO 04-129-79