

Erosion and Sediment Control Schedule

ingress—Egress
A stone access drive complete with under lying geo—textile fabric (20 feet wide and 50 feet long) for ingress and egress at the site shall be installed. This drive shall be the only entrance and exit to the site.

Silt Fence
A silt fence shall be installed prior to any earthwork activities at the site in the locations shown on the site plan as well as along the front of any lot that slopes towards the street.

Temporary Seeding
Disturbed areas of the site that are to remain idle for more than thirty(30) days shall be properly seeded and straw mulched within seven(7) days of completion of intitlal grading. Temporary seeding and mulching ao a thirty(30) foot strip of the entire front of the lot shall be maintained on the site once initial grading is complete

Stabilization of critical areas within fifty(50) feet of any stream or wetland shall be complete within two(2) days of the disturbance if the site is to remain inactive for longer than fourteen(14) days.

Mulching Straw—mulch shall be applied at a rate of 1 bale per every ten (10) feet of curb, at a width of thirty(30) feet to the entire length of the lot. Wood chips may also be used but must be spread at a minimum depth of four inches over the thirty-foot width and must be accompanied by a properly installed silt

<u>maintenance</u>


Erosion and sediment controls shall be inspected every seven(7)


days or within 24 hours of a 0.5" or greater rainfall event

Necessary repairs shall be made at this time.


"I, the undersigned hereby certify that this topography indicated by 6", 1', or 2' contours, and elevations shown hereon represent an actual field survey made by me on the day of day of conditions were taken at appropriate intervals and that as of that date they existed as indicated hereon."

SAN MH RIM 1036.81 INV. 1021.06

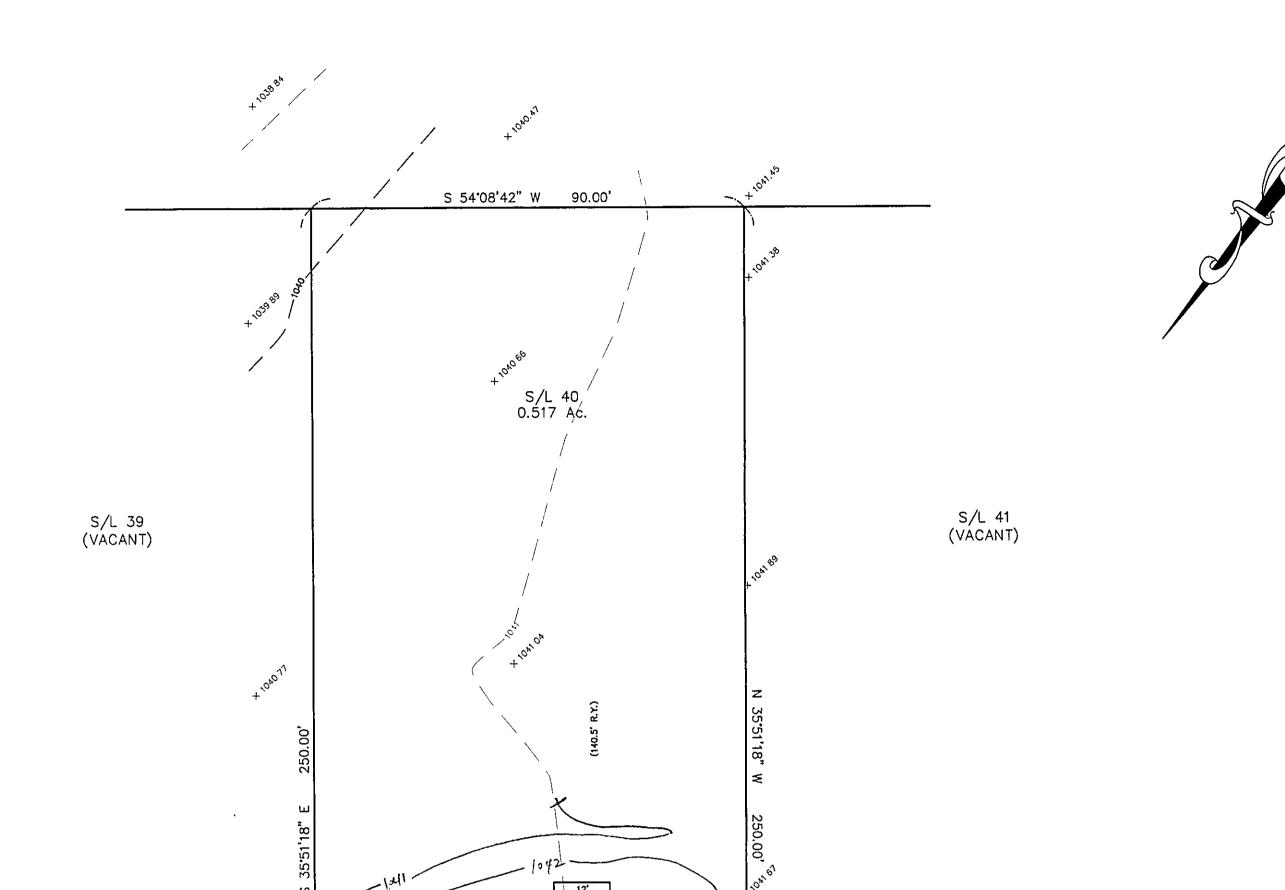

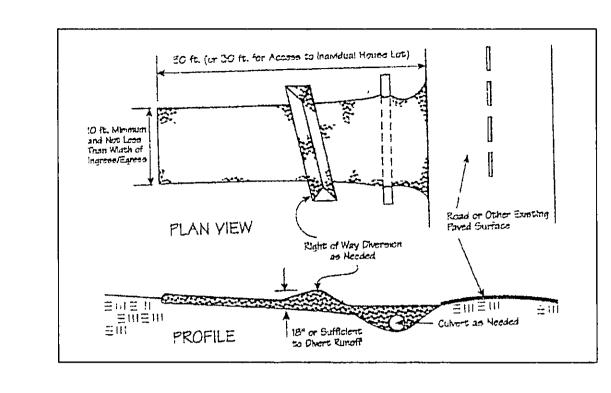

Seeding Dates	Species	Lb /1 000 ft.2	Per Ac
March 1 to August 15	Oars	3	1 bushel
	Tall Fescue	1	40 lb
	Annual Ryograss	1	40 lb
	Perennial Ryegrass	1	40 fts
	Tall Foscue	1	40 lb
	Annual Ryagrass	1	40 lb
August 16 to November 1	Ryn	3	2 bushel
	Tall Fescue	t	40 lb
	Annual Ryegrass	1	40 lb
	Wheat	3	2 bushel
	Tall Fescue	1	40 lb
	Annual Ryegrass	1	40 lb.
	Perennial Byegrass	1	40 lb
	Tall Fescue	1	40 lb
	Annual Ryegrass	1	40 lb

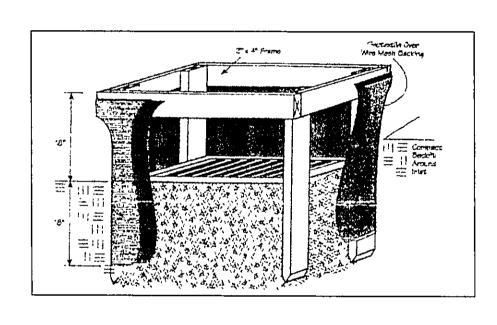

(33.67° S.Y) PROP DRIVE 2' UTILITY EASEMENT STM MH RIM 1041.19 INV. 1034.69 N 54'08'42" E 531.35'

SUMMERWOOD DRIVE - 60'

TBM - PK FND @ 4 PT ELEV - 1040.28

South Air Management Pt. Application to show and and the con-JAMES R. GILLS, P.E. County Drainage Engines, By  $\angle S$ . Date 3/31/05

EXISTING UTILITIES NOTE:
THE SIZE AND LOCATION, BOTH HORIZONTAL AND VERTICAL
OF THE UNDERGROUND UTILITIES SHOWN HEREON, HAVE BEEN
OBTAINED BY A SEARCH OF AVAILABLE RECORDS.
VERIFICATION BY FIELD OBSERVATION HAS BEEN CONDUCTED
WHERE PRACTICAL, HOWEVER, BABCOCK, JONES AND ASSOCIATES
INC. DOES NOT GUARANTEE THE COMPLETENESS NOR ACCURACY
THEREOF.



REV NO.	DESCRIPTION	DATE	BY	CHK,D



BABCOCK, JONES AND ASSOCIATES, INC CIVIL ENGINEERS - SURVEYORS - LAND PLANNERS

PAINESVILLE OHIO 44077

DATE	3/22/05	
DESIGN BY	H.J.	
DRAWN BY	B.P.	<del> </del> 
APPROVED BY	H.J.	S/L 40
CREW CHIEF	E.H.	CONCORD TOWNSHIP

SITE PLAN FOR SHAMROCK CONSTRUCTION

LAKE COUNTY

S/L 40 SUMMERWOOD DRIVE (SUMMERWOOD SUB I.) STATE OF OHIO

SCALE	1"=20'		
JOB NO	04-30	3-40	
SHEET OF			
1		1	