

Erosion and Sediment Control Schedule

Ingress—Egress
A stone access drive complete with under lying geo—textile fabric (20 feet wide and 50 feet long) for ingress and egress at the site shall be installed. This drive shall be the only entrance and exit to the site.

Silt Fence
A silt fence shall be installed prior to any earthwork activities at the site in the locations shown on the site plan as well as along the front of any lot that slopes towards the street.

Temporary Seeding
Disturbed areas of the site that are to remain idle for more than thirty(30) days shall be properly seeded and straw mulched within seven(7) days of completion of intitial grading.
Temporary seeding and mulching as a thirty(30) foot strip of the entire front of the lot shall be maintained on the site once


Stabilization of critical areas within fifty(50) feet of any stream or wetland shall be complete within two(2) days of the disturbance if the site is to remain inactive for longer than fourteen(14) days.


Mulching Straw—mulch shall be applied at a rate of 1 bale per every ten (10) feet of curb, at a width of thirty(30) feet to the entire length of the lot. Wood chips may also be used but must be spread at a minimum depth of four inches over the thirty—foot width and must be accompanied by a properly installed silt

"I, the undersigned hereby certify that this topography indicated by 6", 1', or 2' contours, and elevations shown hereon


represent an actual field survey made by me on the Ray day of Malett 20 5 and that the elevations were taken at appropriate intervals and that as of that date they existed as indicated hereon."

Maintenance
Erosion and sediment controls shall be inspected every seven(7) days or within 24 hours of a 0.5" or greater rainfall event.
Necessary repairs shall be made at this time.

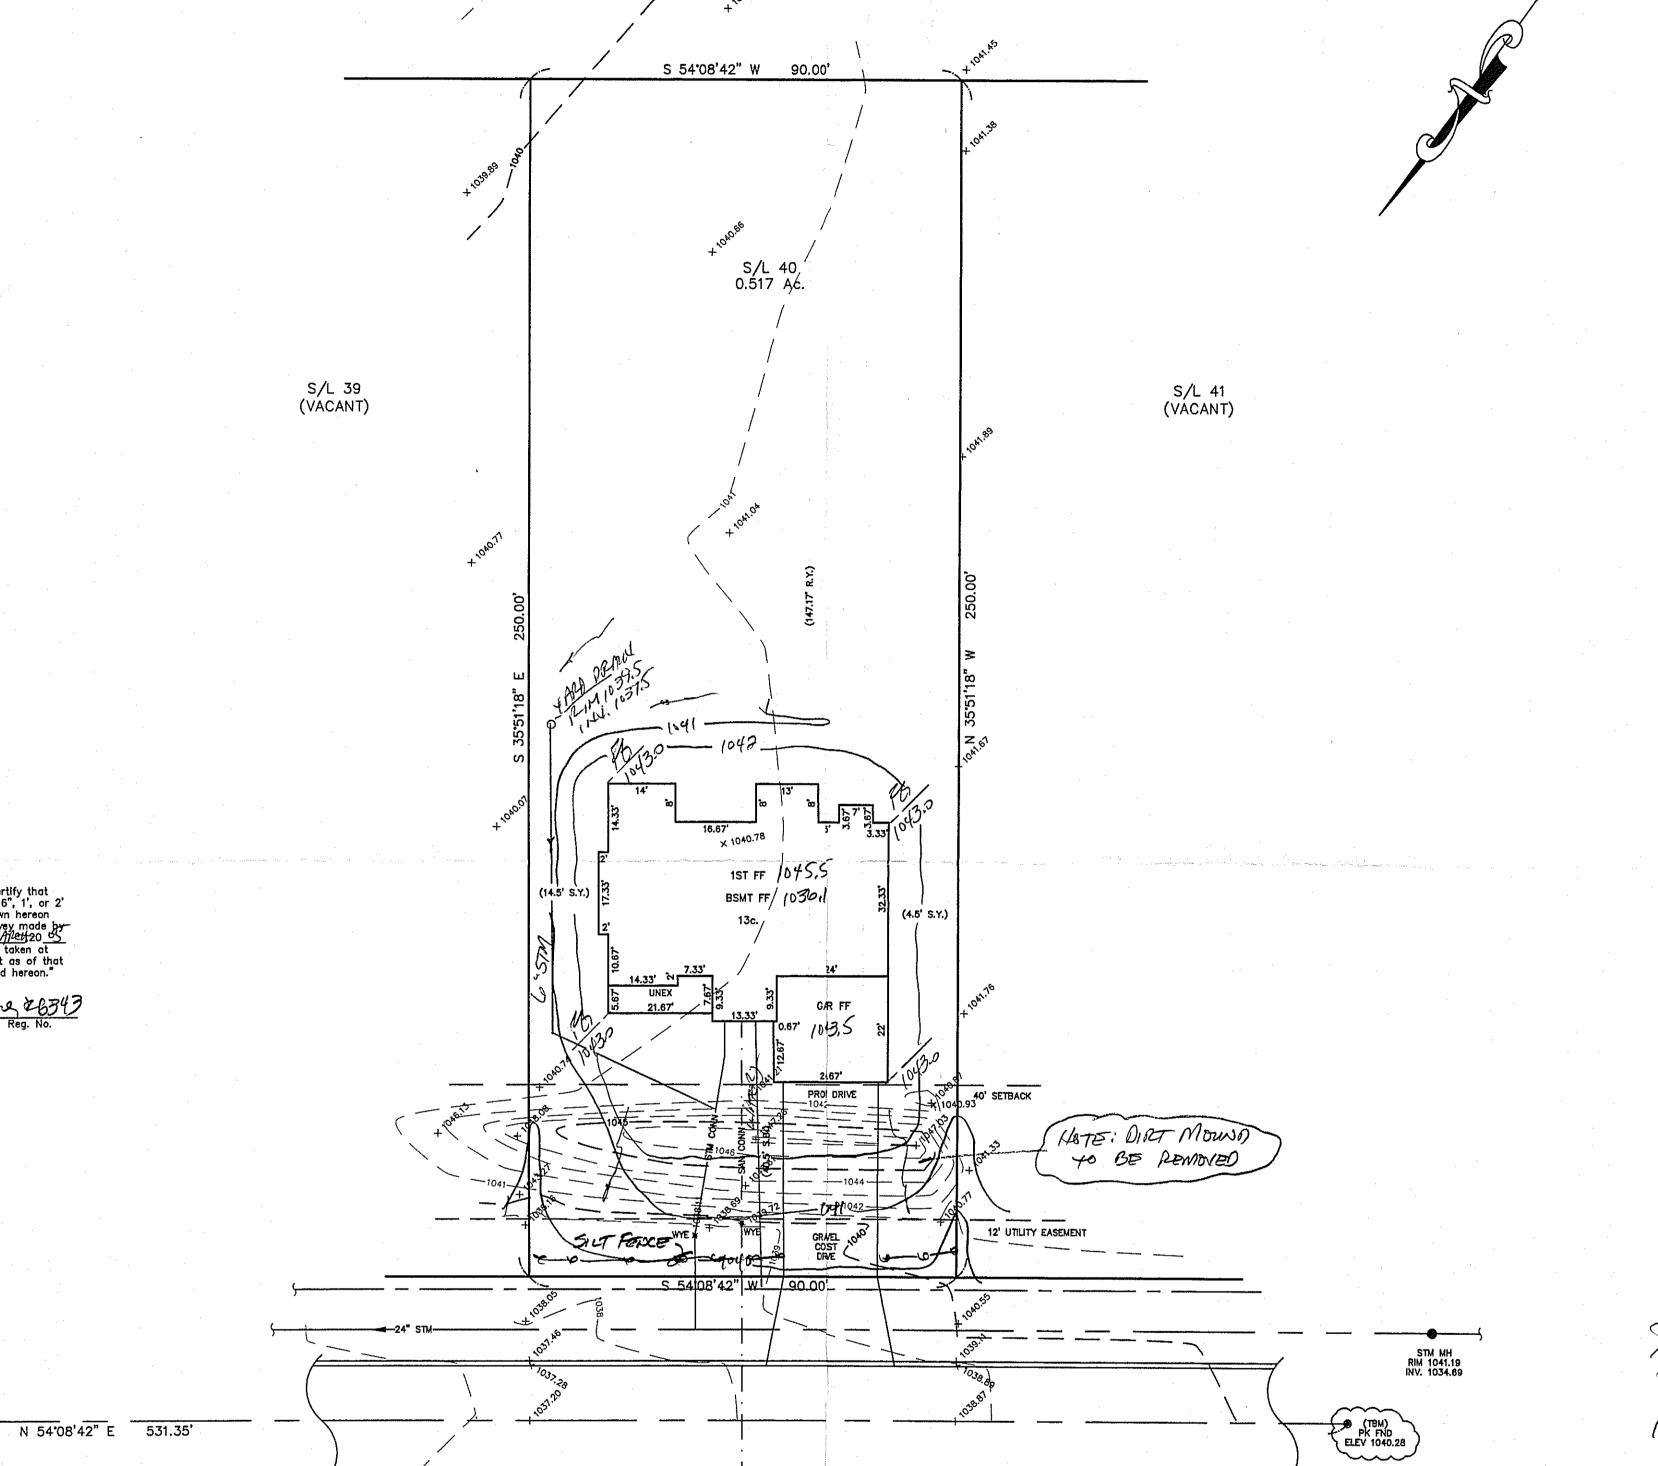

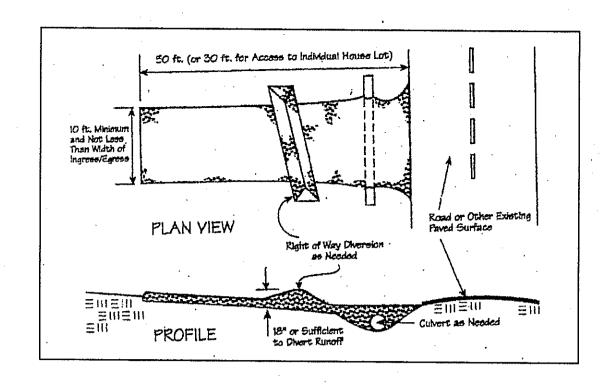

Seeding Dates	Species	Lb./1,000 ft. ²	Per Ac.
March 1 to August 15	Oats Tall Fescue Annual Ryagrass	3 · 1 1	4 bushel 40 lb. 40 lb.
	Perennial Ryegrass Tall Fescue Annual Ryegrasa	1 1 1	40 lb. 40 lb. 40 lb.
August 16 to November 1	Rye Toll Fescue Annual Ryegrass	3 1 1	2 bushel 40 lb. 40 lb.
	Wheat Tall Foscue Annual Ryegrass	3 1 1	2 bushel 40 lb. 40 lb.
	Perennial Ryegrass Toll Fescue Annual Ryegrass	1 1 1	40 lb. 40 lb. 40 lb.

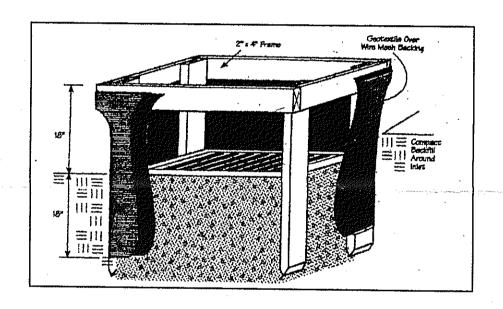

CONCORD TOWNSHIP ZONING OFFICE Zoning Permit # 107010 - 12564

Date Issued 128106

Subject to Approval By:
Lake Co. Engineer/Storm Water Mgmt. Lake Co. Soil + Water District ☐ Lake Co. Health District Dake Co. Building Dept.

> TBM - PK FND @ Q PT ELEV - 1040.28

Stormwater Management Plan
Approved as clown and/or noted
JAMES N. GILLS, P.E.

EXISTING UTILITIES NOTE:
THE SIZE AND LOCATION, BOTH HORIZONTAL AND VERTICAL
OF THE UNDERGROUND UTILITIES SHOWN HEREON, HAVE BEEN
OBTAINED BY A SEARCH OF AVAILABLE RECORDS.
VERIFICATION BY FIELD OBSERVATION HAS BEEN CONDUCTED
WHERE PRACTICAL, HOWEVER, BABCOCK, JONES AND ASSOCIATES
INC. DOES NOT GUARANTEE THE COMPLETENESS NOR ACCURACY
THEREOF.



REV NO.	DESCRIPTION	DATE	BY	CHK'D
1	ADDED NEW HOUSE	2/22/06	B.P.	H.J.
3	ADDED VALL DRAIL	3/3/06	HT	加
		· · ·	,	

SUMMERWOOD DRIVE - 60'

BABCOCK, JONES AND ASSOCIATES, INC. CIVIL ENGINEERS - SURVEYORS - LAND PLANNERS PAINESVILLE OHIO 44077

DATE	3/22/05
DESIGN BY	H.J.
DRAWN BY	B.P.
APPROVED BY	H.J.
CREW CHIFF	

SITE PLAN SHAMROCK CONSTRUCTION

1"=20' JOB NO 04-303-40

***	·					
	•					
_	5/1 40	SUMMERWOOD DRIVE (SUMMERWOOD	CIID	1.5		
٦		SOMMENTOOD DIVIAT (20MMT1/AAOOD	306	1.)		
	CONCORD TOWNSHIP	LAKE COUNTY		CTATE	ΩF.	\cap L