

# SITE PLAN

For : Vintage Homes

CLIENT

6520 Hopkins Rd.

Mentor

ADDRESS STREET CITY

12 Cambden Creek Est. #1

SUBDIVISION NAME VOL PAGE

LOT TRACT CITY/TOWNSHIP

OHIO

By

Stormwater Management Plan  
Approved as shown and/or noted

JAMES R. GILLIS, P.E.  
County Drainage Engineer

Date 5/27/06

**LAND DESIGN consultants**  
Civil Engineers and Surveyors

8505 EAST AVENUE - MENTOR, OHIO 44060


TELEPHONE 216-843-5544 FAX 216-843-9511

## DESIGN CERTIFICATION

THIS PLAN WAS PREPARED BY ME, AND IS CORRECT TO THE BEST OF MY KNOWLEDGE AND BELIEF.

*James R. PEGORARO* 5/4/06  
NAME

CHECK LIST

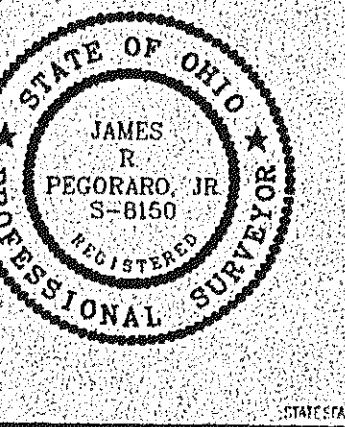

I, THE UNDERSIGNED, HEREBY CERTIFY THAT THIS TOPOGRAPHY, INDICATED BY E. 1. OR 2. CONTOURS AND ELEVATIONS SHOWN HEREON, REPRESENT AN ACTUAL FIELD SURVEY MADE BY ME ON THE 24TH DAY OF March, 2006 AND THAT THE ELEVATIONS WERE TAKEN AT APPROPRIATE INTERVALS AND THAT AS OF THAT DATE THEY EXISTED AS INDICATED HEREON.

James R. Pegoraro, Jr. P.S.B.150

## "AS BUILT" CERTIFICATION

I HEREBY CERTIFY THAT THE CIRCLED INFORMATION IS EXISTING AS OBTAINED ON THE SITE AND IS CORRECT TO THE BEST OF MY KNOWLEDGE AND BELIEF.

NAME

LEGEND

DRAWN BY JRP SCALE 1"=20'

CHKD BY/FIELD DATE

F.G.100.0 = PROP. ELEV.

1 Site/Gde 3/29/06

2 Rev: Fnd& Grades 5/4/06

BENCHMARK:  
Rim of Sanitary Manhole Shown

Abbreviated Site Plan - Erosion and Sediment Control Notes  
(Individual Homesites) (5-13-05)

### Ingress-Egress

A stone access drive complete with under lying geo-textile fabric (20 feet wide and 50 feet long) for ingress and egress at the site shall be installed. This drive shall be the only entrance and exit to the site.

### Silt Fence

All silt fence shall be installed prior to any earthwork activities at the site in the locations shown on the site plan as well as along the front of any lot that slopes towards the street.

### Temporary Seeding

Disturbed areas of the site that are to remain idle for more than Twenty-one (21) days shall be properly seeded and straw mulched within seven (7) days of completion of initial grading. Temporary seeding and mulching of a thirty (30) foot strip of the entire front of the lot shall be maintained on the site once initial grading is complete.

Stabilization of critical areas within fifty (50) feet of any stream or wetland shall be complete within two (2) days of the disturbance if the site is to remain inactive for longer than fourteen (14) days.

### Mulching

Straw-mulch shall be applied at a rate of 1 bale per every ten (10) feet of curb, at a width of thirty (30) feet of the entire length of the lot. Wood chips may also be used but must be spread at a minimum depth of four inches over the thirty-foot width and must be accompanied by a properly installed silt fence.


### Maintenance

Erosion and sediment controls shall be inspected every seven (7) days or within 24 hours of a 0.5" or greater rainfall event. Necessary repairs shall be made at this time.

### Note:

All erosion and sediment control specifications, applications, and timetables are based on the descriptions and standards of The Ohio Department of Natural Resources "Rainwater and Land Development Manual" and can be found in the Lake County Erosion and Sediment Control Rules as adopted December 21, 1999.

The specified erosion and sediment control standards are general guidelines and shall not limit the right of the county to impose, at any time, additional, more stringent requirements. Nor shall the standards limit the right of the county to

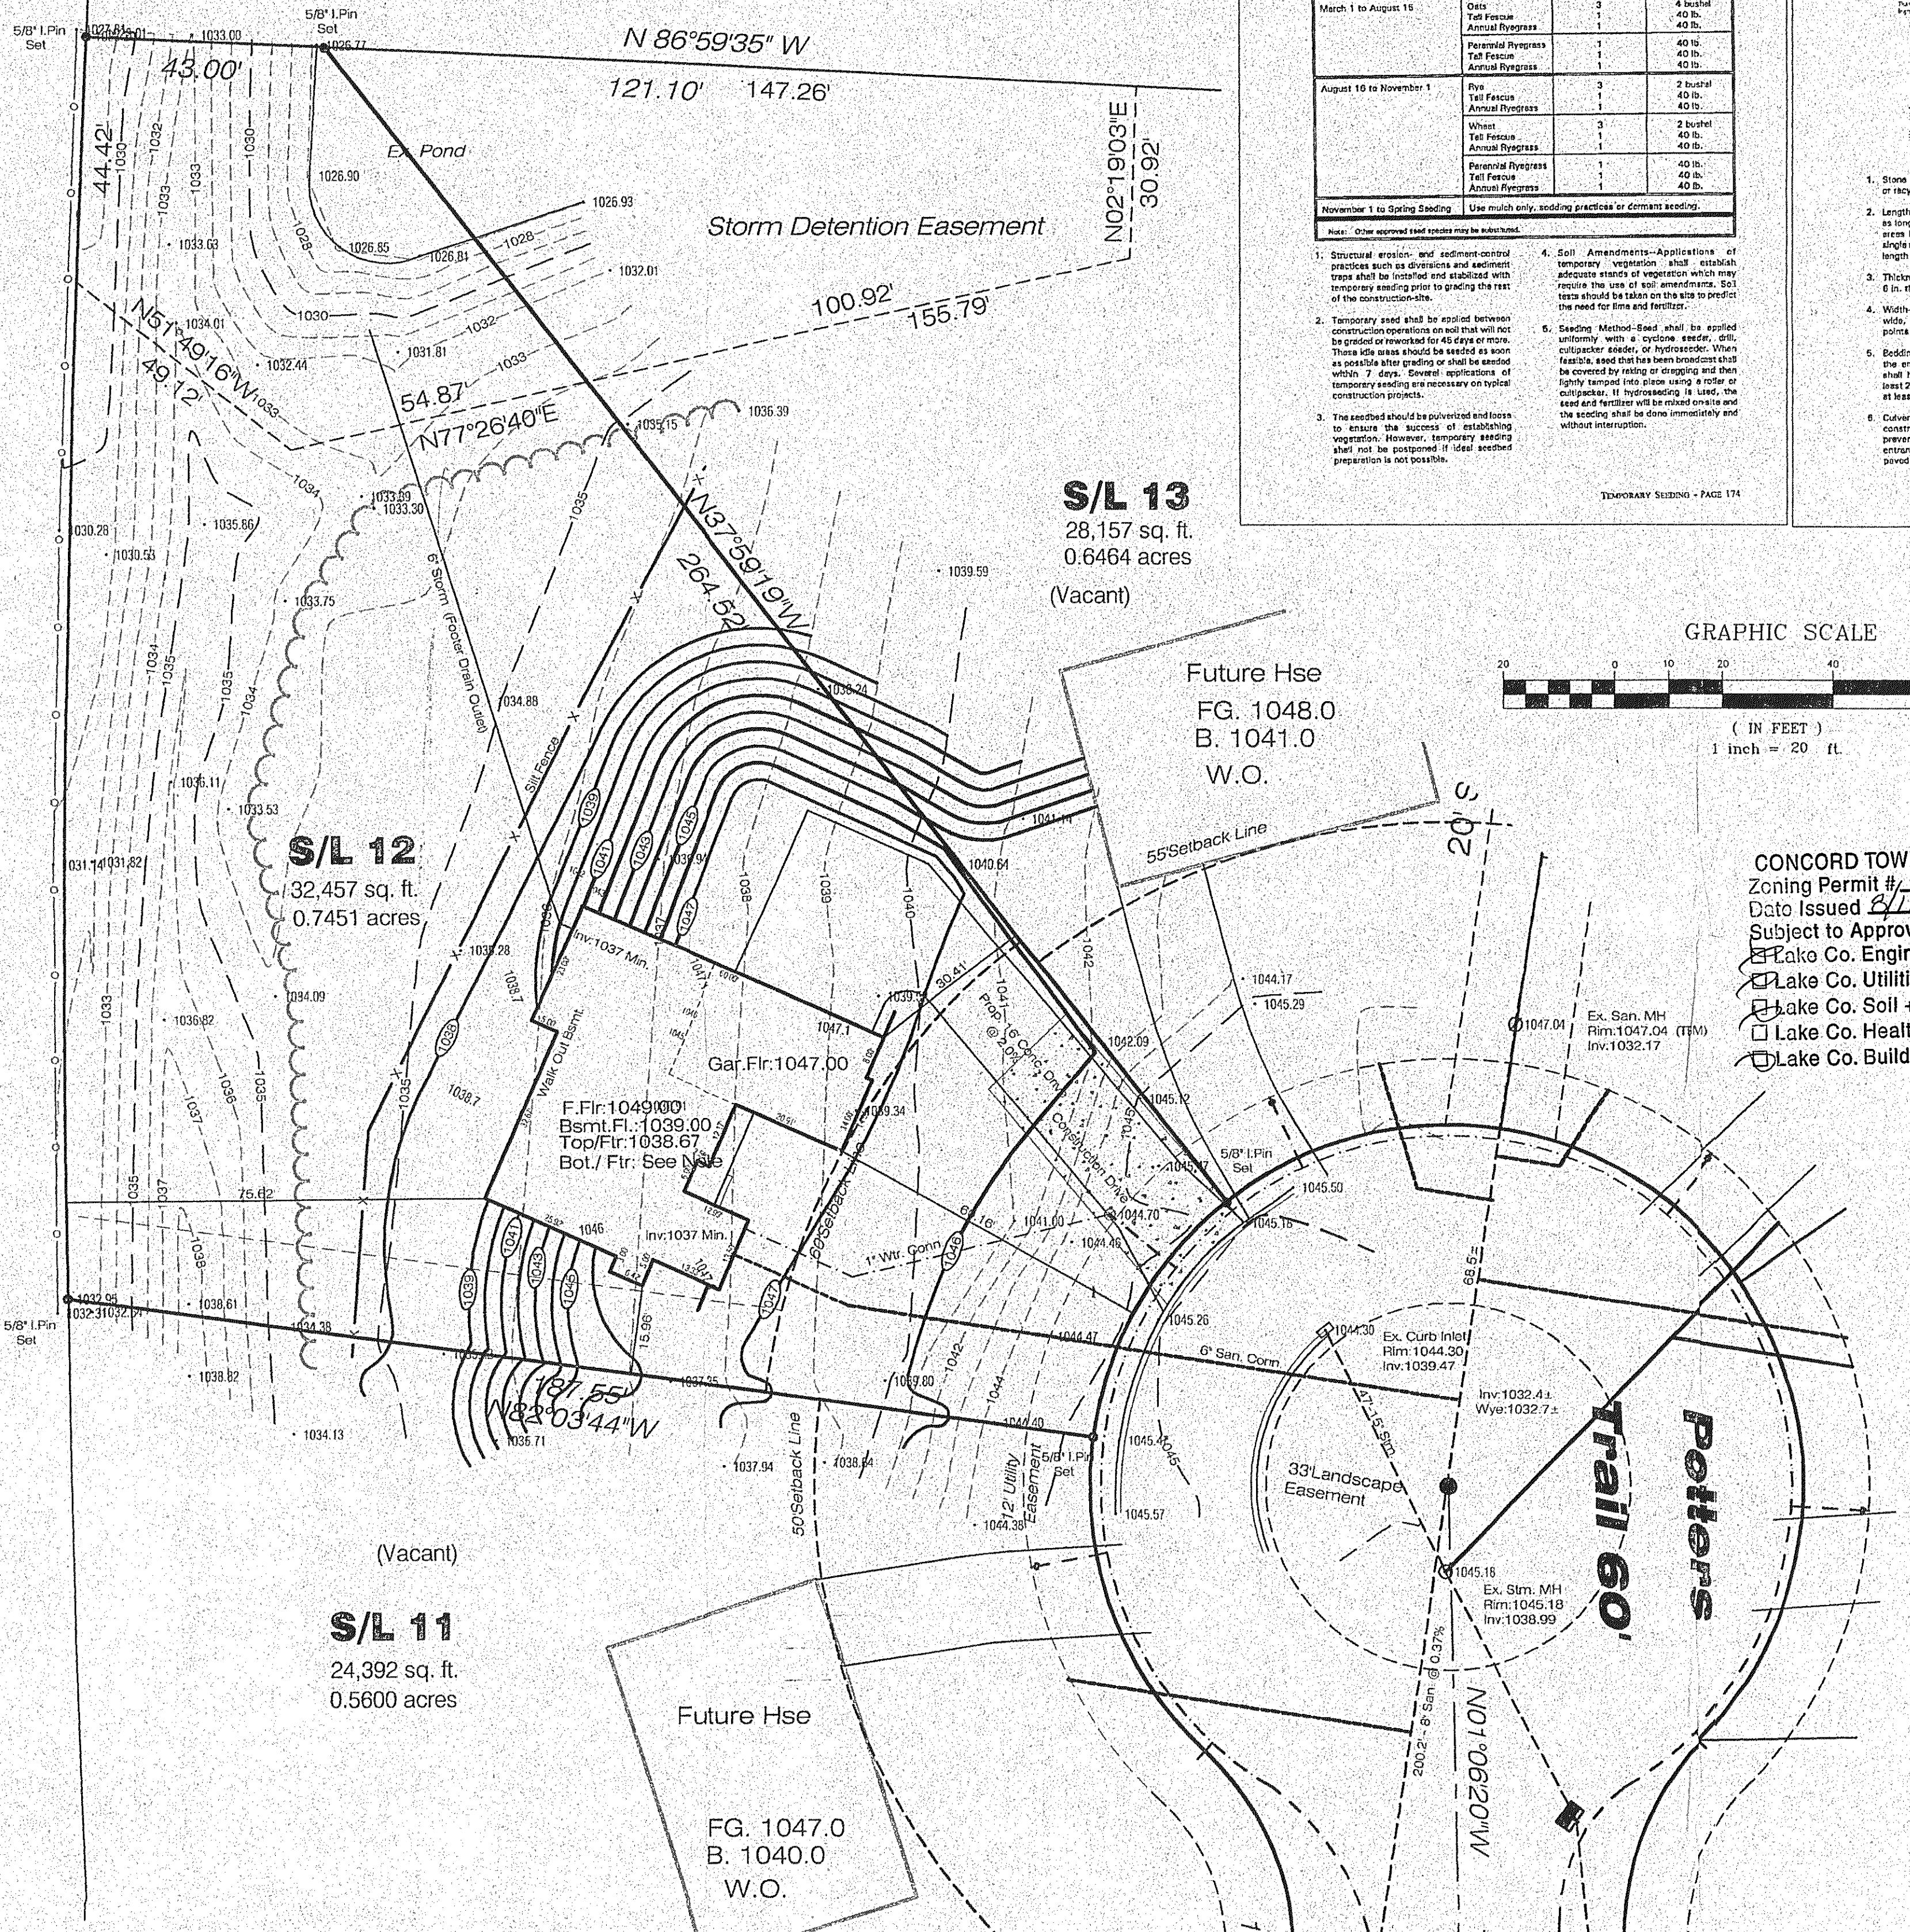

EXISTING UNDERGROUND UTILITIES NOTE:  
THE SIZE & LOCATION, BOTH HORIZONTAL AND VERTICAL,  
OF THE UNDERGROUND UTILITIES SHOWN HEREON, HAVE BEEN  
OBTAINED BY A SEARCH OF AVAILABLE RECORDS.  
VERIFICATION BY FIELD OBSERVATION HAS BEEN CONDUCTED  
WHERE PRACTICAL; HOWEVER, LDC INC. DOES NOT  
GUARANTEE THE COMPLETENESS NOR ACCURACY THEREOF.

2 WORKING DAYS  
BEFORE YOU DIG  
CALL TOLL FREE 800-362-2764  
OHIO UTILITIES PROTECTION SERVICE

DWG. NAME  
Vinh1-0601