

Erosion and Sediment Control Schedule

A stone access drive complete with under lying geo—textile fabric (20 feet wide and 50 feet long) for ingress and egress at the site shall be installed. This drive shall be the only entrance and exit to the site.

<u>Silt Fence</u>

A silt fence shall be installed prior to any earthwork activities at the site in the locations shown on the site plan as well as along the front of any lot that slopes towards the street.


Temporary Seeding
Disturbed areas of the site that are to remain idle for more than thirty(30) days shall be properly seeded and straw mulched within seven(7) days of completion of intitial grading. Temporary seeding and mulching ao a thirty(30) foot strip of the entire front of the lot shall be maintained on the site once initial grading is complete.

Stabilization of critical areas within fifty(50) feet of any stream or wetland shall be complete within two(2) days of the disturbance if the site is to remain inactive for longer than fourteen(14) days.


Mulching
Straw-mulch shall be applied at a rate of 1 bale per every ten (10) feet of curb, at a width of thirty(30) feet to the entire length of the lot. Wood chips may also be used but must be spread at a minimum depth of four inches over the thirty—foot width and must be accompanied by a properly installed silt

Erosion and sediment controls shall be inspected every seven(7) days or within 24 hours of a 0.5" or greater rainfall event.


Necessary repairs shall be made at this time.

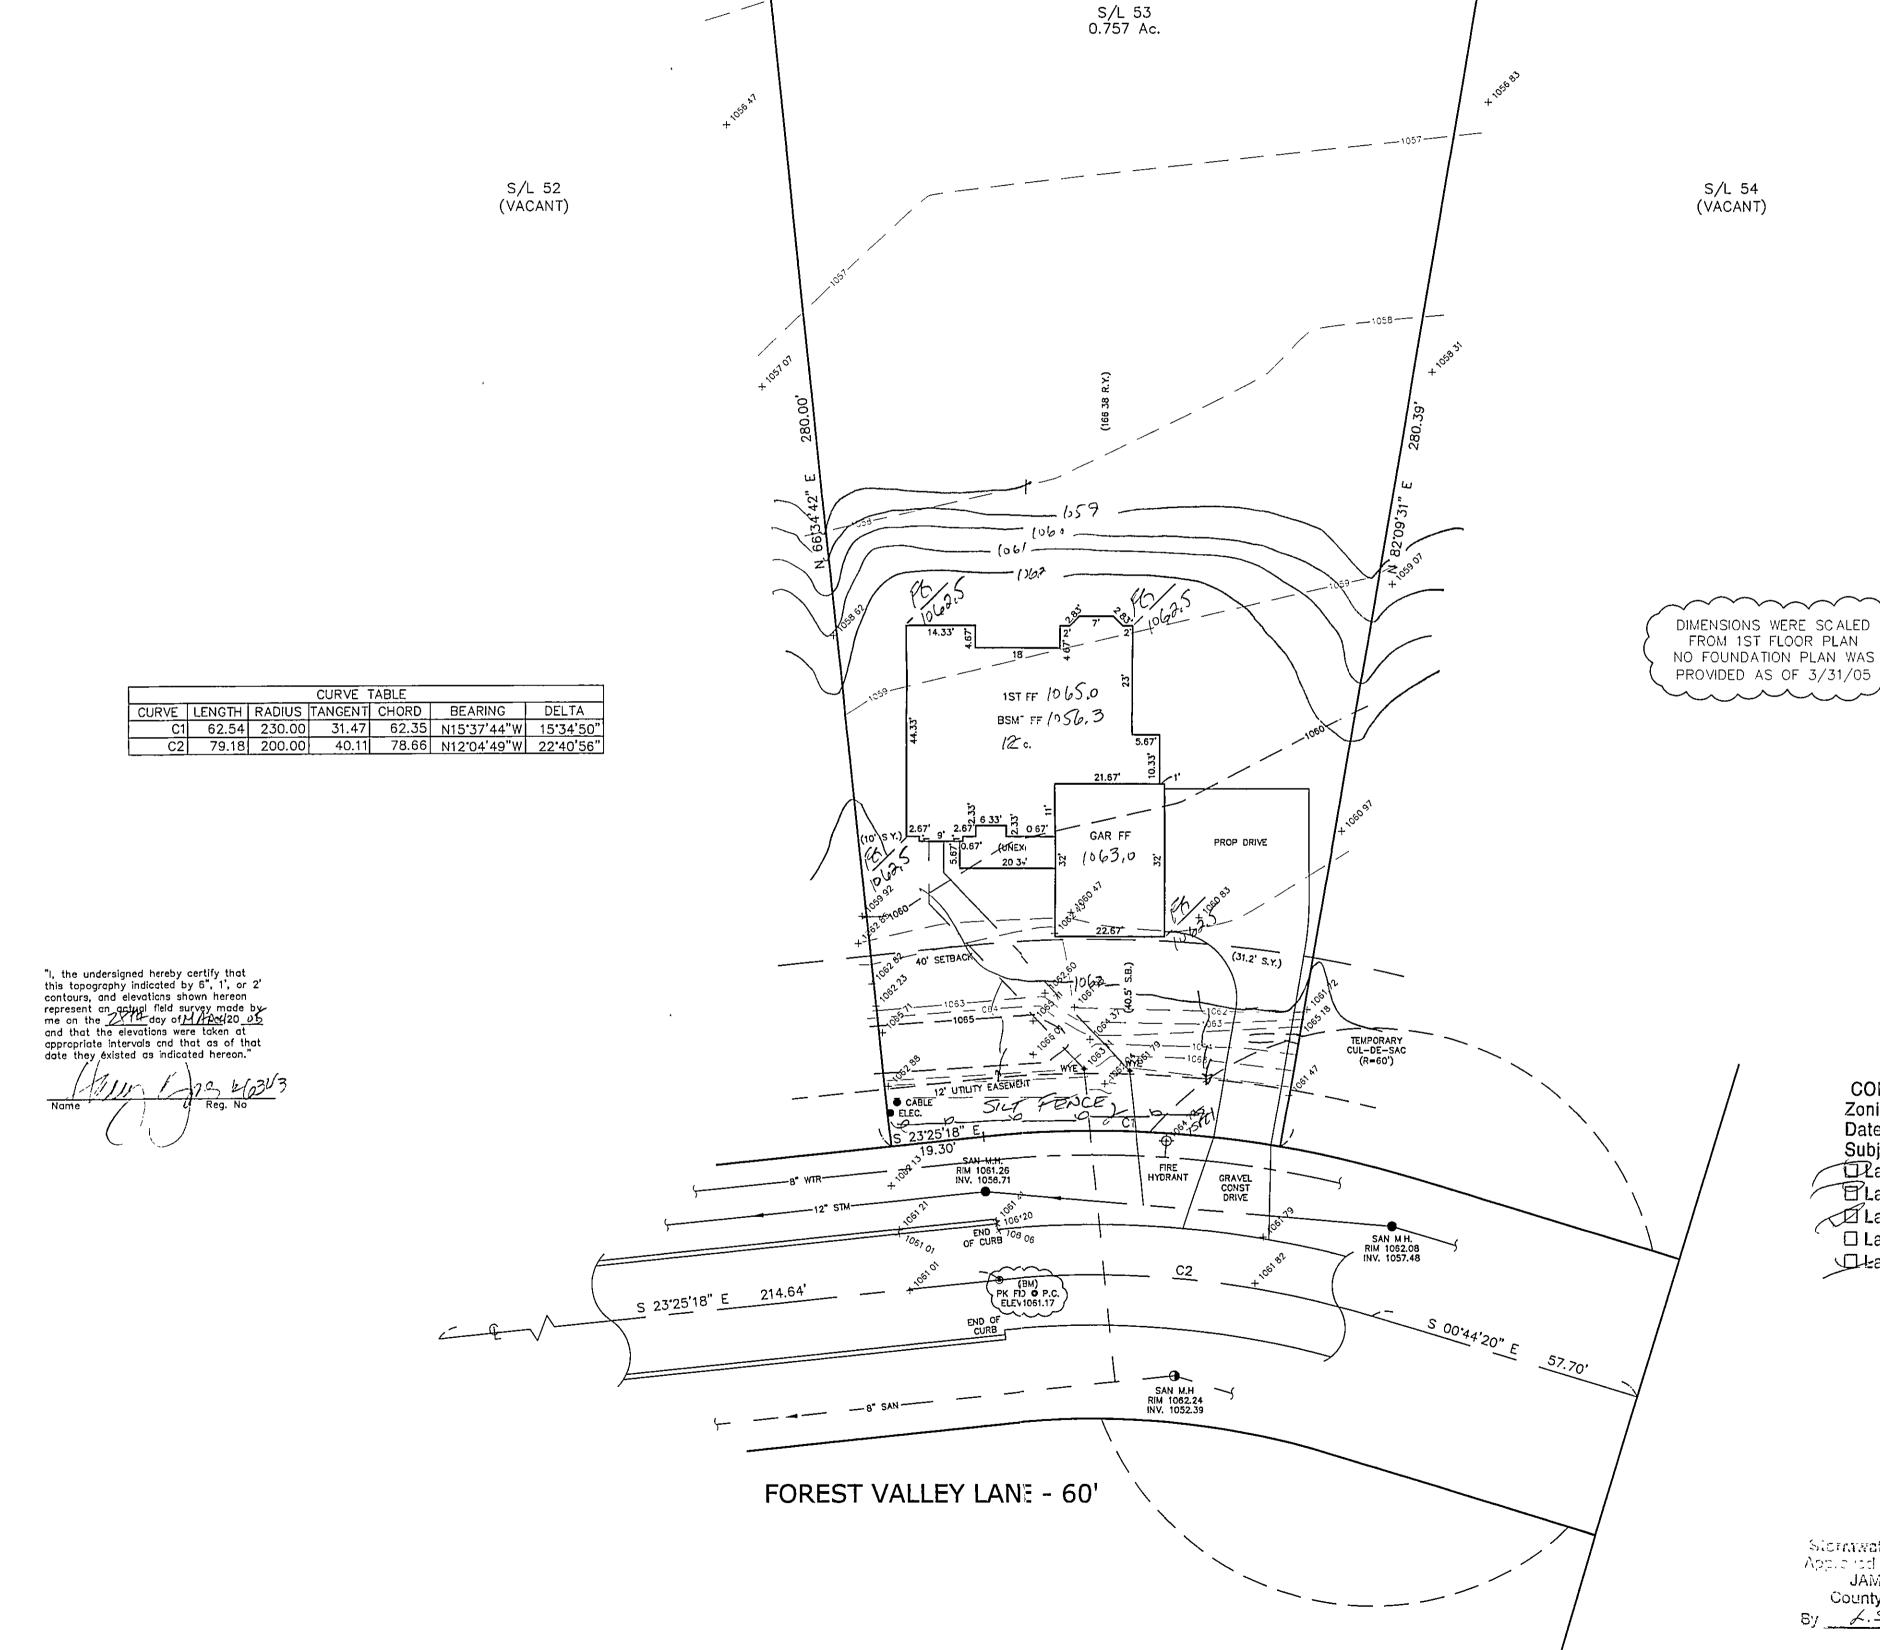

S 16'43'23" E 157.46'

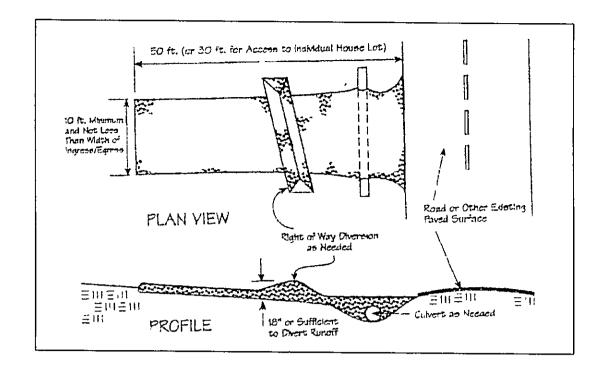

Seeding Dates	Species	Lb /1,000 ft ²	Per Ac
March 1 to August 15	Oats	3	4 bushel
	Tall Fescue	1	40 lb.
	Annual Ryegrass	1	40 lb
	Perennial Ryegrass	1	40 lb.
	Tail Fescue	1	40 lb
	Annuel Byegrass	1	\$0 lb
August 16 to November 1	Rve	3	2 bushet
	Tall Fescue	i	40 lb
	Annua' Ryegrass	1	10 16
	Wheat	3	2 bushet
	Tall Fracue	ï	40 lb
	Annual Ryegrass	1	40 lb
	Perennial Ryegrass	1	40 lb
	Tall Fescue	1	40 lb
	Annual Byegrass	1	40 lb
November 1 to Spring Seeding	Use mulch only godd	ing practices or dorms	et codice

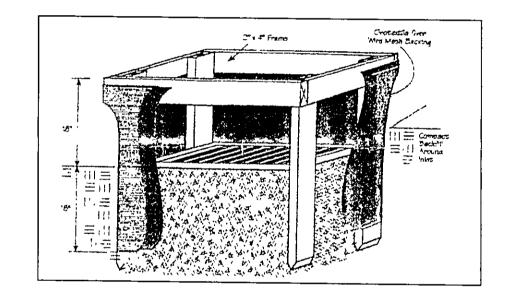

CONCORD TOWNSHIP ZONING OFFICE Zoning Permit # 0405-/2095
Date Issued 4/4/05

Subject to Approval By: Pake Co. Engineer/Storm Water Mgmt.

PLake Co. Utilities Dept.

Lake Co. Soil · Water District ☐ Lake Co. Health District Lake Co Building Dept.

Sistemwater Management Fig. Appliered as shown and/or not JAMES R. GILLS, P.E. County Drainage Engineer / / By L.S. Date 4/8/05

CONCORD TOWNSHIP

EXISTING UTILITIES NOTE:
THE SIZE AND LOCATION, BOTH HORIZONTAL AND VERTICAL
OF THE UNDERGROUND UTILITIES SHOWN HEREON, HAVE BEEN
OBTAINED BY A SEARCH OF AVAILABLE RECORDS. VERIFICATION BY FIELD OBSERVATION HAS BEEN CONDUCTED WHERE PRACTICAL, HOWEVER, BABCOCK, JONES AND ASSOCIATES INC. DOES NOT GUARANTEE THE COMPLETENESS NOR ACCURACY THEREOF.

TBM - PK FND @ P.C. ELEV - 1061.17



REV NO.	DESCRIPTION	DATE	BY	CHK'D
				-



BARCOCK JONES AND ASSOCIATES INC

DATE	3/31/05	
DESIGN BY	H.J.	
DRAWN BY	B.P.	
APPROVED BY	H.J.	
CREW CHIEF	E.H.	CC

SITE PLAN SHAMROCK CONSTRUCTION

S/L 53 FOREST VALLEY LANE (SUMMERWOOD SUB I.)

LAKE COUNTY

	1"=20'		
	JOB NO 04-303-53	3	
	SHEET OF		
UB I.)	1 / 1		
STATE OF OHIO	/		

ABCUCK, JUNES AND ASSUCIATES, INC	<u> </u>
ABCOCK, JUNES AND ASSOCIATES, INC	DRA
CIVIL ENGINEERS — SURVEYORS — LAND PLANNERS	APP
	APP
PAINESVILLE OHIO 44077	CRE