

Erosion and Sediment Control Schedule

Ingress—Egress
A stone access drive complete with under lying geo—textile fabric (20 feet wide and 50 feet long) for ingress and egress at the site shall be installed. This drive shall be the only entrance and exit to the site.

## Silt Fence A silt fence shall be installed prior to any earthwork activities at the site in the locations shown on the site plan as well as along the front of any lot that slopes towards the street.

Temporary Seeding
Disturbed areas of the site that are to remain idle for more than twenty—one(21) days shall be properly seeded and straw mulched within seven(7) days of completion of intitial grading.

Temporary seeding and mulching as a thirty(30) foot strip of the entire front of the lot shall be maintained on the site once


Stabilization of critical areas within fifty(50) feet of any stream or wetland shall be complete within two(2) days of the disturbance if the site is to remain inactive for longer than fourteen(14) days.


initial grading is complete.


Mulching
Straw—mulch shall be applied at a rate of 1 bale per every ten
(10) feet of curb, at a width of thirty(30) feet to the entire
length of the lot. Wood chips may also be used but must be
spread at a minimum depth of four inches over the thirty—foot
width and must be accompanied by a properly installed silt

Erosion and sediment controls shall be inspected every seven(7) days or within 24 hours of a 0.5" or greater rainfall event.


Necessary repairs shall be made at this time.

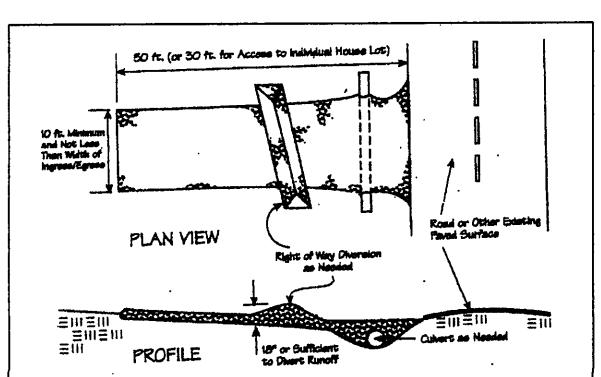

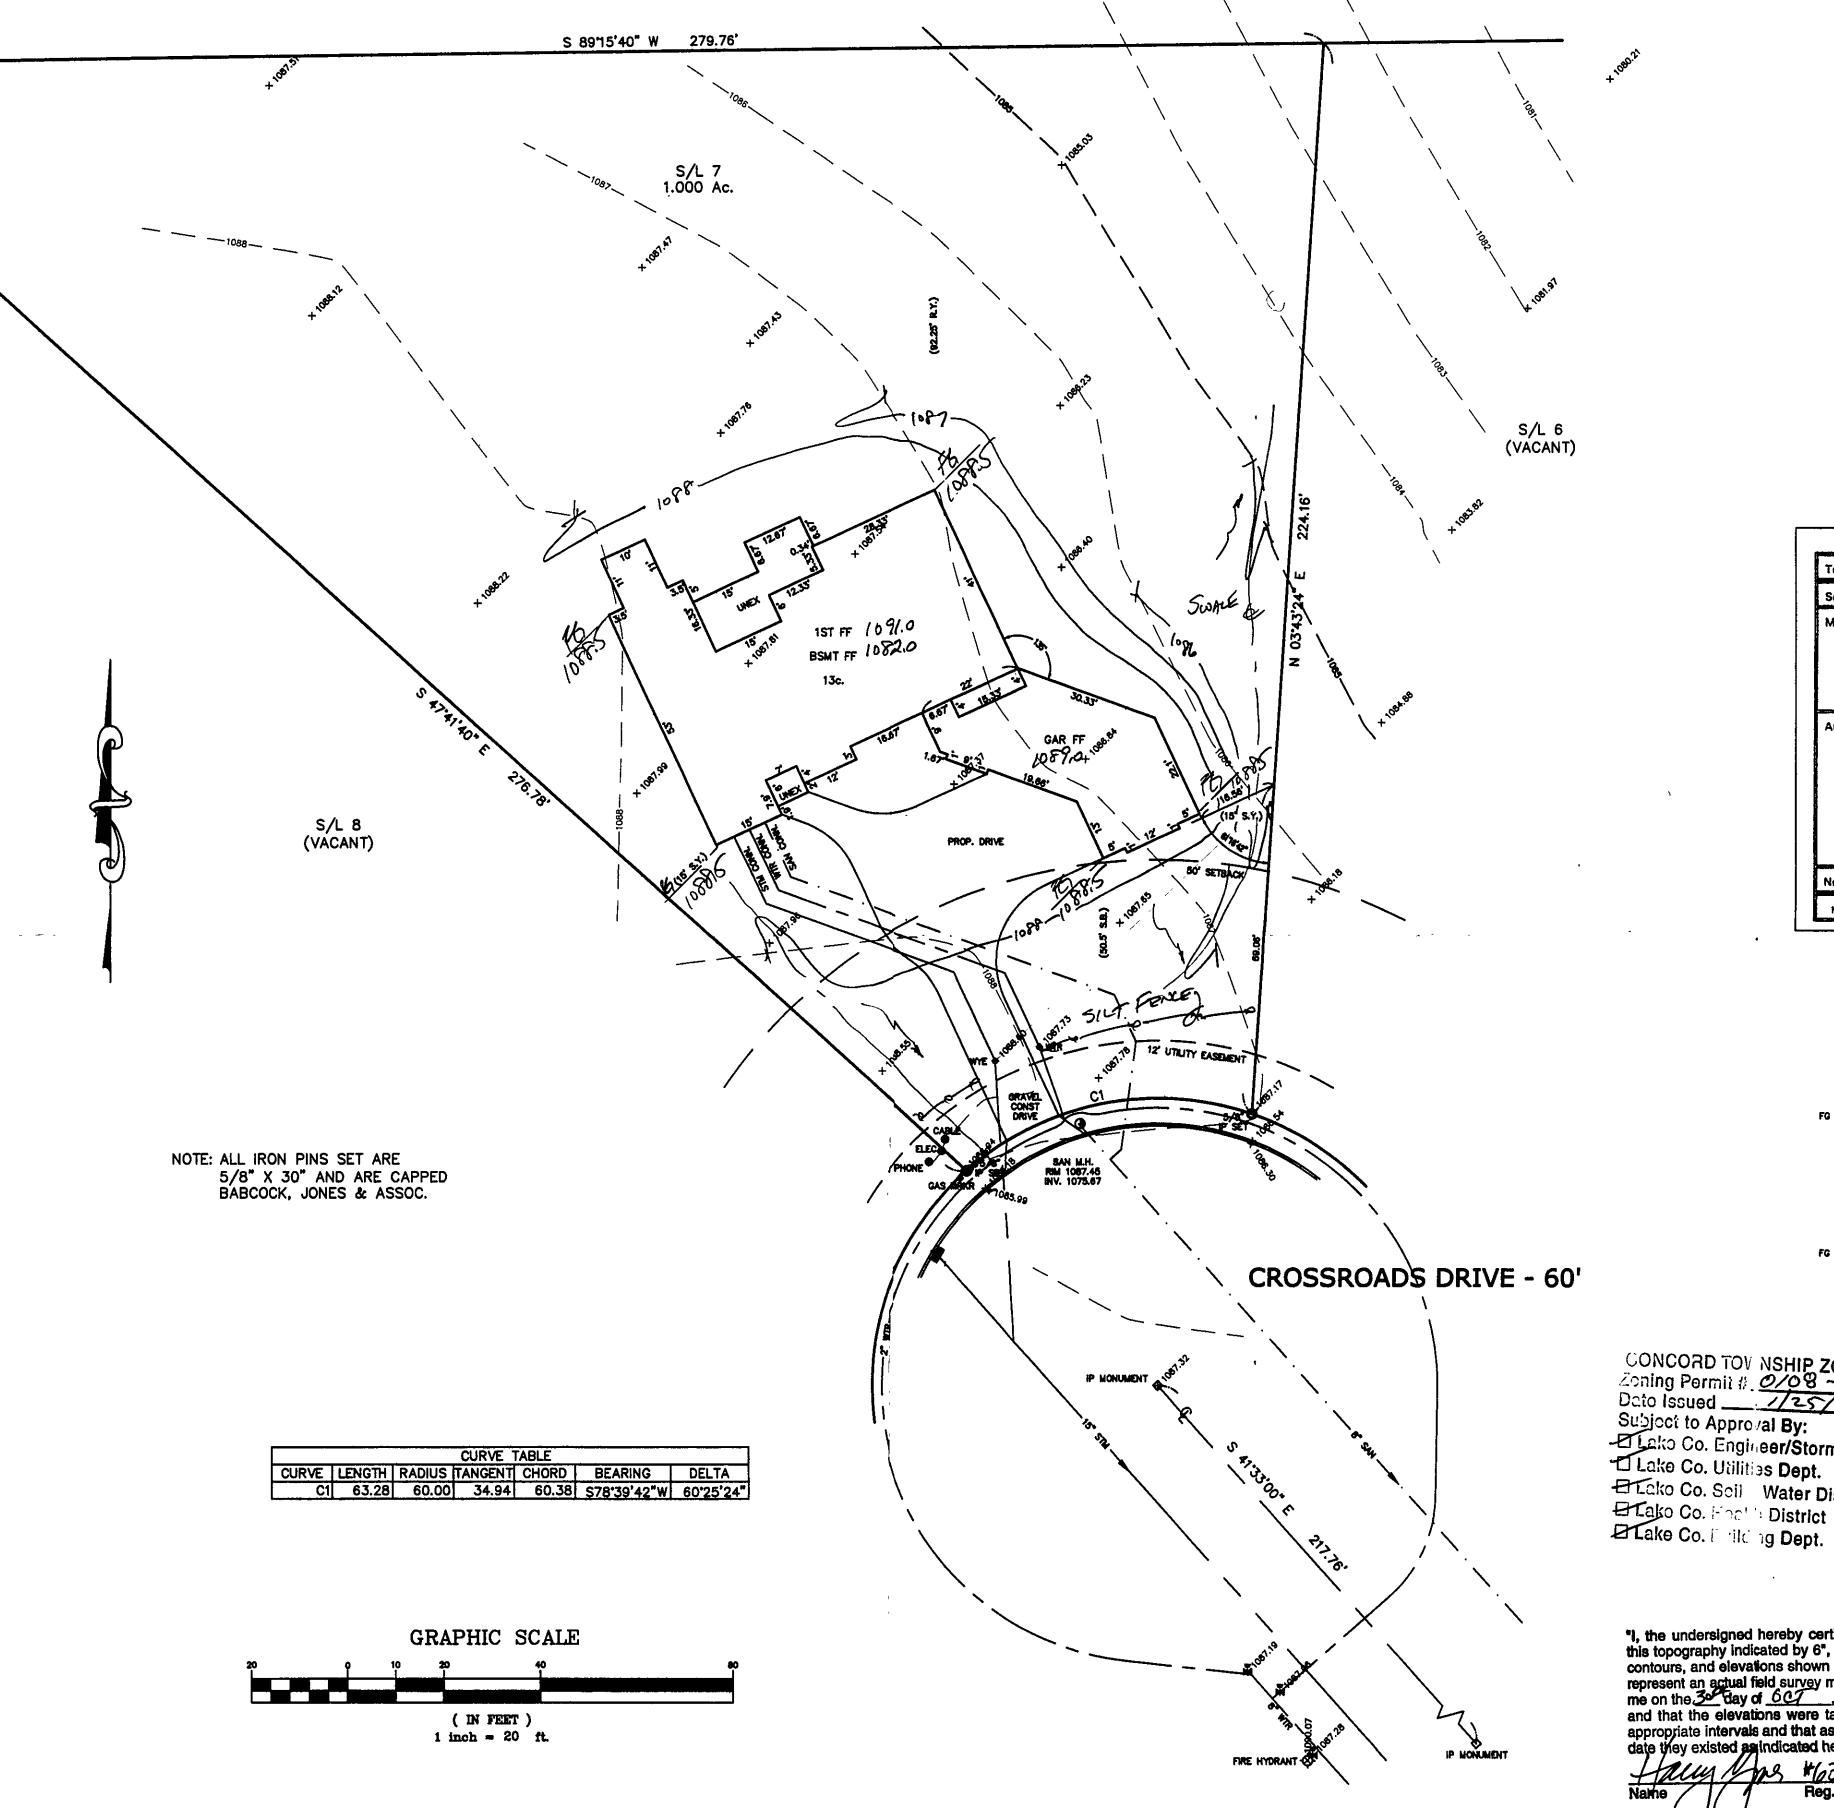

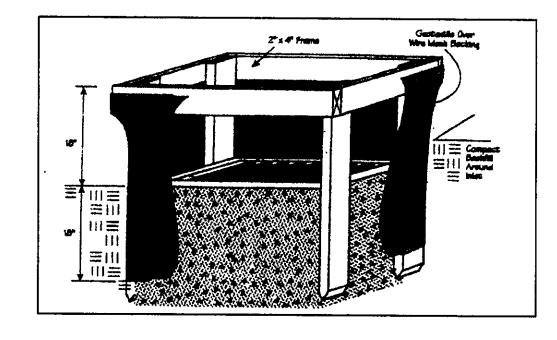

eding Dates	Species	Lb./1,000 ft. <sup>2</sup>	Per Ac.
March 1 to August 15	Oats	3 .	4 bushe
	Tall Fescue	1	40 lb.
	Annual Ryegrass	1	40 lb.
	Perennial Ryegrass	1	40 lb.
	Tall Fescue	1	40 lb.
	Annual Ryegrass	1	40 lb.
August 16 to November 1	Rys	3	2 bushel
	Tall Fescue	i	40 lb.
	Annual Ryegrass	1	40 lb.
	Wheat	3	2 bushel
	Tall Fescue	1	40 lb.
	Annual Ryegrass	1	40 lb.
	Perennial Ryegrass	1	40 lb.
	Tall Fescue	1	40 lb.
	Annual Ryegrass	1	40 lb.

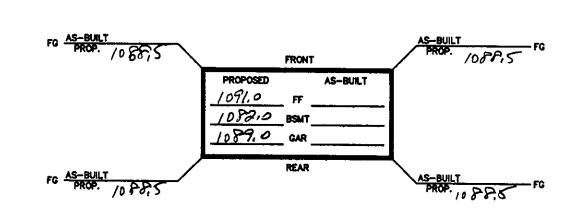

CONCORD TOV NSHIP ZONING OFFICE Zoning Permit # 0/08 - /3380
Dato Issued \_\_\_\_\_\_/25/08 Subject to Approval By: Leko Co. Engineer/Storm Water Mgmt. Lake Co. Utilities Dept. Elako Co. Soil Water District E Cako Co. Foo! 's District

"I, the undersigned hereby certify that this topography indicated by 6", 1' or 2' contours, and elevations shown hereon represent an actual field survey made by me on the day of 607, 2007 and that the elevations were taken at appropriate intervals and that as of that date they existed agindicated hereon."

A control of Claragery (1) A control of Clarager County Drainage Engineer, By 15 Date 1/30/08

TBM - SANITARY MANHOLE ELEV - 1087.45

EXISTING UTILITIES NOTE:
THE SIZE AND LOCATION, BOTH HORIZONTAL AND VERTICAL
OF THE UNDERGROUND UTILITIES SHOWN HEREON, HAVE BEEN
OBTAINED BY A SEARCH OF AVAILABLE RECORDS.
VERIFICATION BY FIELD OBSERVATION HAS BEEN CONDUCTED
WHERE PRACTICAL, HOWEVER, BABCOCK, JONES AND ASSOCIATES
INC. DOES NOT GUARANTEE THE COMPLETENESS NOR ACCURACY
THEREOF.



REV NO.	DESCRIPTION	DATE	BY	CHK'D
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DATE	11/9/07	•
DESIGN BY	H.J.	
DRAWN BY	B.P.	
APPROVED BY	H.J.	S/L 7 CROSSR
CREW CHIEF	W.B.	CONCORD TOWNSHIP

SITE PLAN DISTINCTIVE HOMES S/L 7 CROSSROADS DRIVE (CROSSROADS AT SUMMERWOOD SUB)

LAKE COUNTY

1"=20' **JOS NO** 07-036-7 STATE OF OHIO

BABCOCK, JONES AND ASSOCIATES, I						
CIVIL ENGINEERS - SURVEYORS - LAND PLANNERS						
PAINESVILLE OHIO 44077						