Erosion and Sediment Control Schedule

A stone access drive complete with under lying geo—textile fabric (20 feet wide and 50 feet long) for ingress and egress at the site shall be installed. This drive shall be the only entrance and exit to the site.


A silt fence shall be installed prior to any earthwork activities at the site in the locations shown on the site plan as well as along the front of any lot that slopes towards the street.


Disturbed areas of the site that are to remain idle for more than thirty(30) days shall be properly seeded and straw mulched within seven(7) days of completion of intitial grading. Temporary seeding and mulching as a thirty(30) foot strip of the entire front of the lot shall be maintained on the site once initial grading is complete.


Stabilization of critical areas within fifty(50) feet of any stream or wetland shall be complete within two(2) days of the disturbance if the site is to remain inactive for longer than fourteen(14) days.

Mulching
Straw—mulch shall be applied at a rate of 1 bale per every ten (10) feet of curb, at a width of thirty(30) feet to the entire length of the lot. Wood chips may also be used but must be spread at a minimum depth of four inches over the thirty-foot width and must be accompanied by a properly installed silt

Erosion and sediment controls shall be inspected every seven(7) days or within 24 hours of a 0.5" or greater rainfall event. Necessary repairs shall be made at this time.

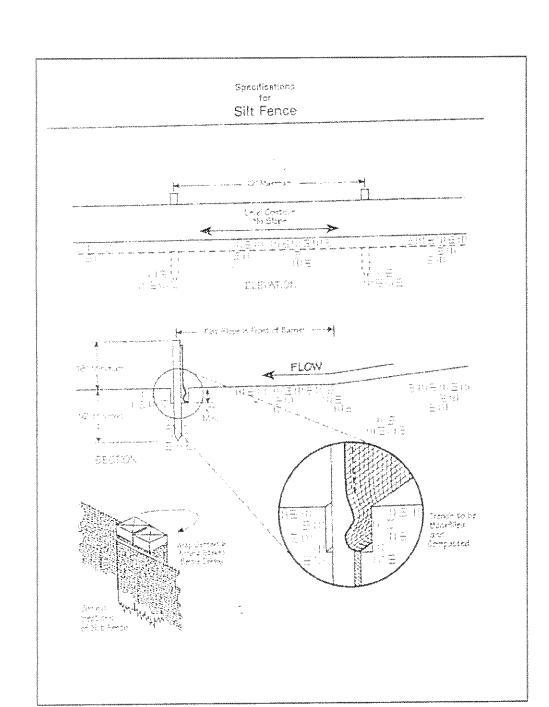


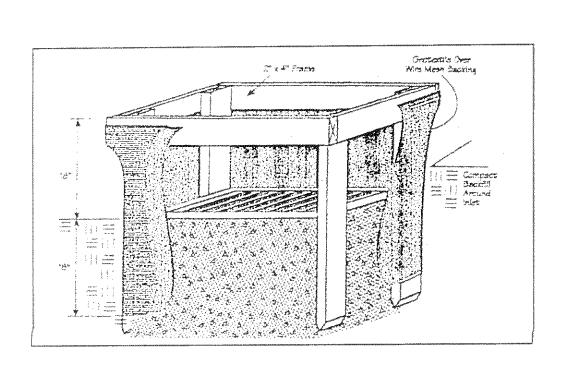

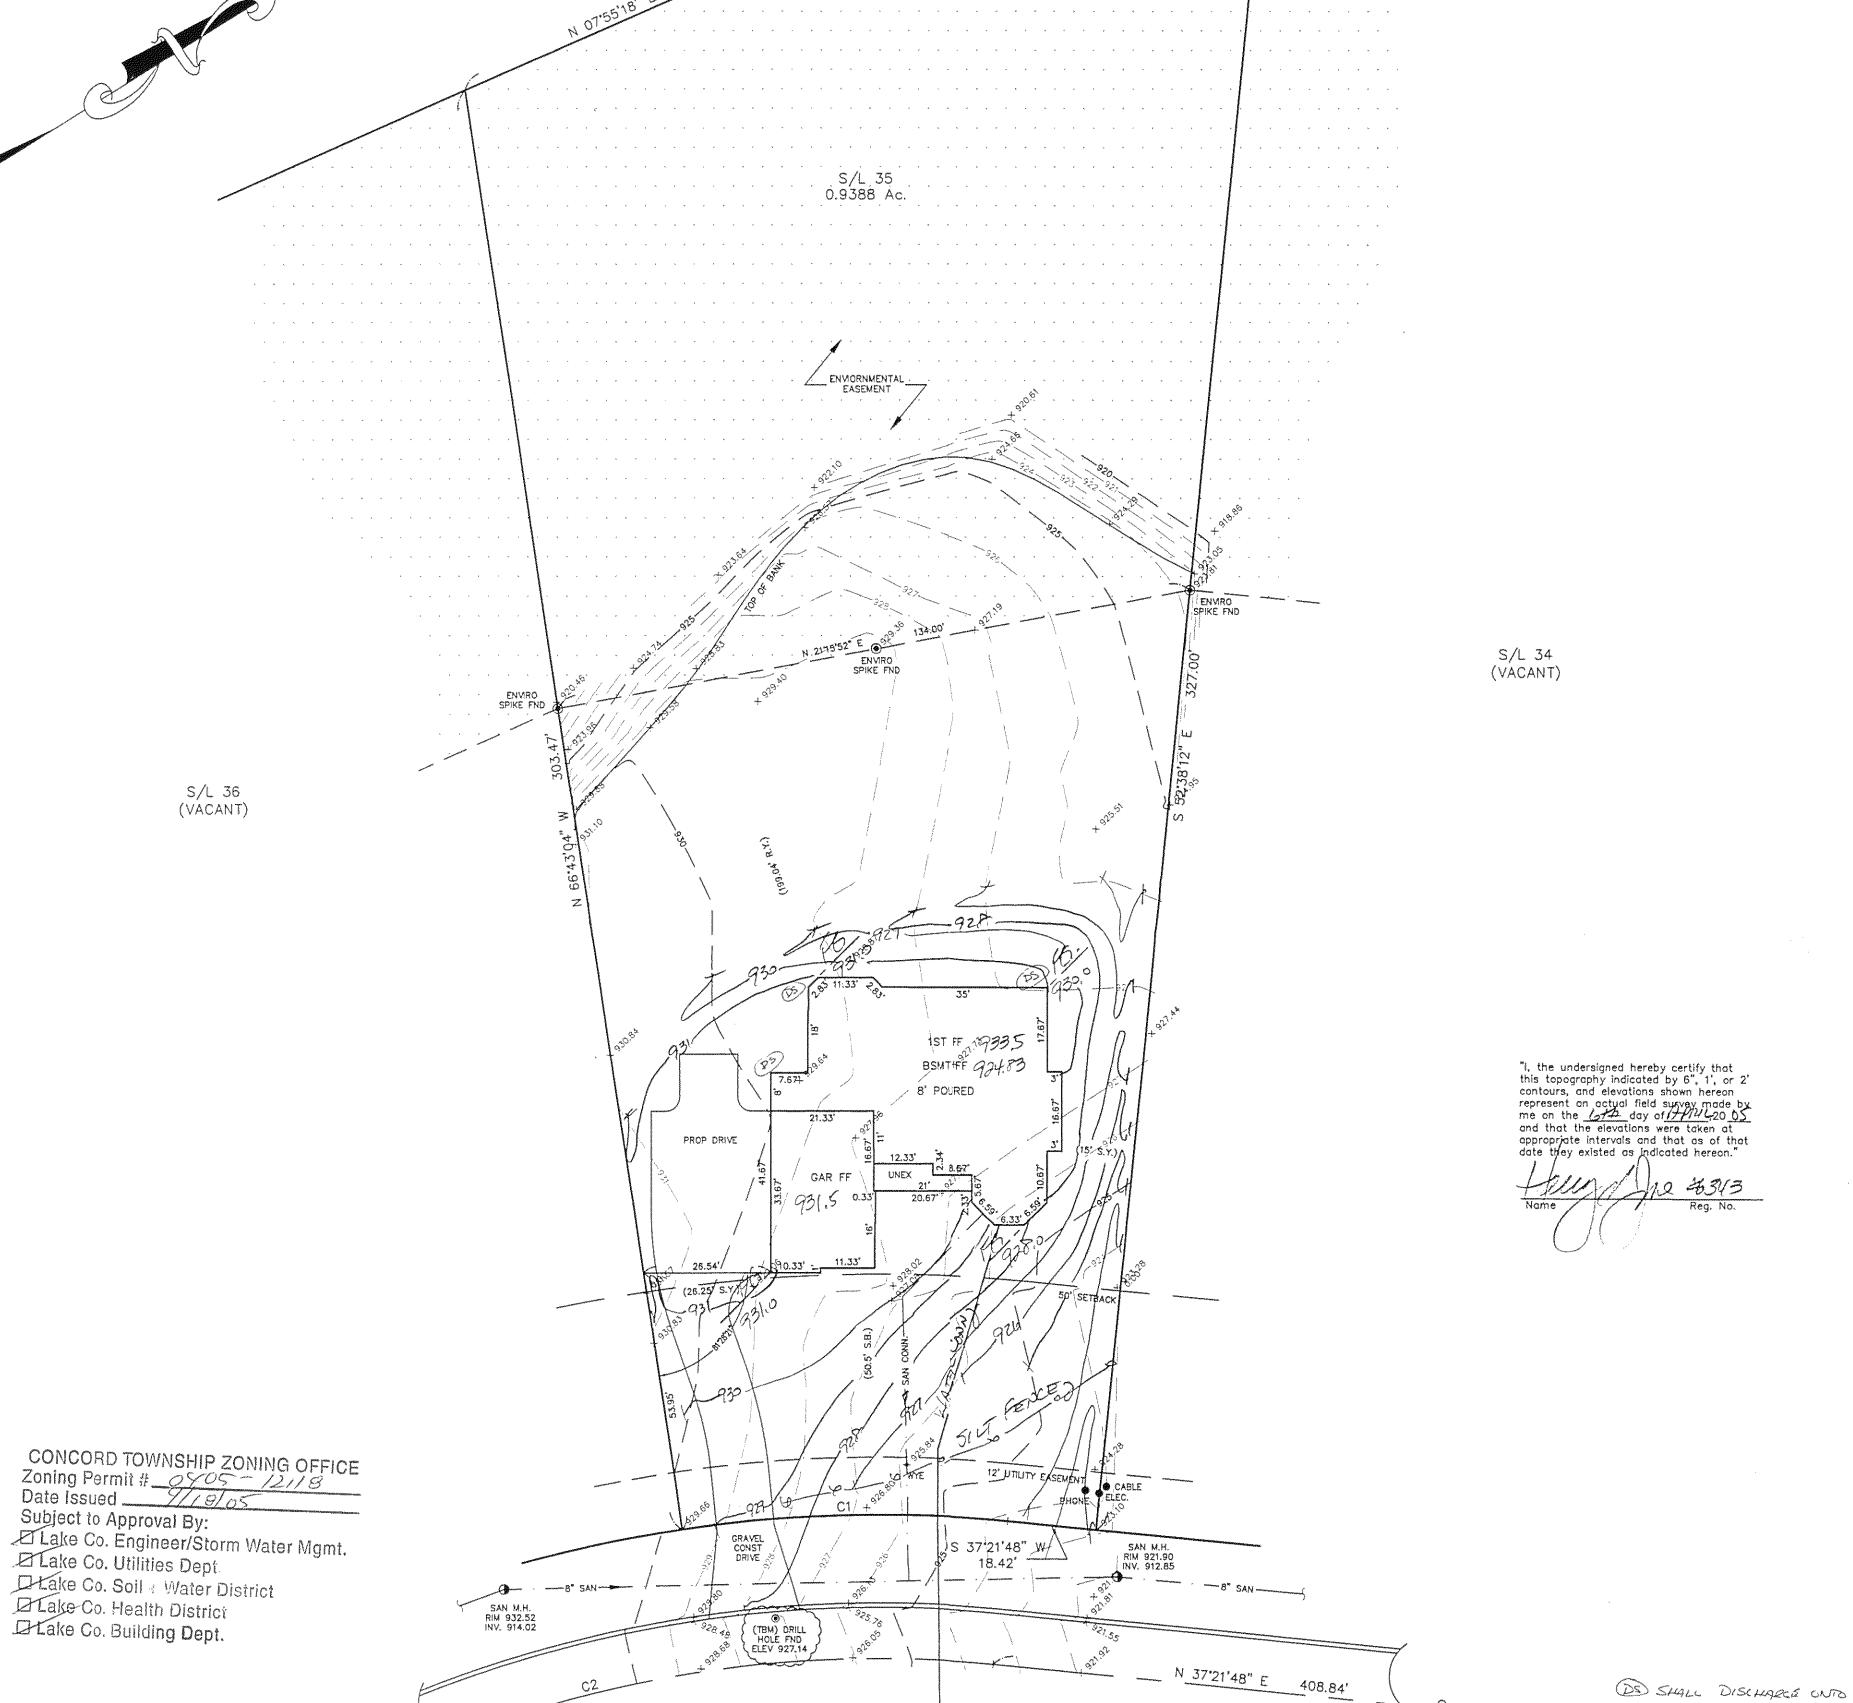

N 37'21'48" E 87.62'

Temporary Seeding Species Selection Seeding Dates Species Lb./1,000 ft.² Per Ac. March 1 to August 15 4 bushel Tall Fescue 40 lb. Annual Ryegrass 40 lb. Perennial Ryegrass 40 lb. Tall Fescue 40 lb. Annual Ryegrass 40 lb. August 16 to November 1 2 bushel Tall Fescue 40 lb. Annual Ryegrass 40 lb. 2 bushel Tall Fescue 40 lb. Annual Ryegrass 40 lb. Perennial Ryegrass 40 lb. 40 lb. Tall Fescue Annual Ryegrass 40 lb. November 1 to Spring Seeding Use mulch only, sodding practices or dormant seeding. Note: Other approved seed species may be substituted.

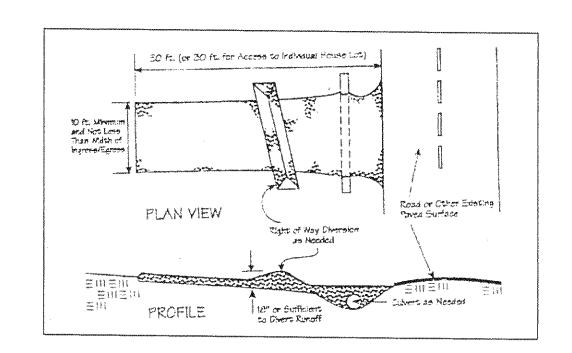

TBM - DRILL HOLE FND ELEV - 927.14

CURVE TABLE

CURVE LENGTH RADIUS TANGENT CHORD BEARING DELTA

C1 68.81 280.00 34.58 68.64 S30'19'17"W 14'04'49" C2 169.63 250.00 88.22 166.39 S17*55'32"W 38*52'31"

DS SHALL DISCHARCE ONTO EPLANT BLOCKS

Stormwater Management Figh Approved as shown and/or noted JAMES R. GILLS, P.E. County Drainage Engineer/ J.S. Date 4/19/05 EXISTING UTILITIES NOTE:

THE SIZE NND LOCATION, BOTH HORIZONTAL AND VERTICAL

OF THE UNDERGROUND UTILITIES SHOWN HEREON, HAVE BEEN

OBTAINED BY A SEARCH OF AVAILABLE RECORDS.

VERIFICATION BY FIELD OBSERVATION HAS BEEN CONDUCTED

WHERE PRACTICAL, HOWEVER, BABCOCK, JONES AND ASSOCIATES

INC. DOES NOT GUARANTEE THE COMPLETENESS NOR ACCURACY

THEREOF.



REV NO.	DESCRIPTION	DATE	BY	CHK'D
See Constitution of the Co				
***************************************		***************************************	***************************************	

BUTTERFLY STREET - 60'

SAN M.H. RIM 926.34 INV. 922.74

BABCOCK, JONES AND ASSOCIATES, INC CIVIL ENGINEERS - SURVEYORS - LAND PLANNERS PAINESVILLE OHIO 44077

DATE 4/7/05	
DESIGN BY	H.J.
DRAWN BY	B.P.
APPROVED BY	H.J.
CREW CHIEF	

SITE PLAN MILT PAVLISIN CUSTOM HOMES INC.

1'' = 20'Јов NO 04-129-35 SHEET

0500-804DQ-2-					
waxaanaabook sal	S/L	35 BUTTERFLY	STREET (THE NATURE	PRESERVE NORTH SUB)	
	CONCORD	TOWNSHIP	LAKE COUNTY	STATE OF OHIO	